

LINCOLN PARK PLANNING COMMISSION

CITY HALL – COUNCIL CHAMBERS 1355 SOUTHFIELD ROAD LINCOLN PARK, MICHIGAN

April 10, 2019 at 7:00 p.m.

AGENDA

- I. Call to Order
- II. Pledge of Allegiance
- III. Roll Call
- IV. Approval of Previous Minutes
- V. Approval of Agenda
- VI. Old Business
 - A. Public Hearing: 26182 Outer Drive Supportive Housing Apartments
 - B. Special Land Use: 26182 Outer Drive Supportive Housing Apartments
 - C. Site Plan Review: 26182 Outer Drive Supportive Housing Apartments
- VII. New Business
- VIII. Policy Review and Discussion
- IX. Reports from Department and Other Boards and Commissions
- X. Public Comments
- XI. Comments from Planning Commissioners
- XII. Adjournment

The City of Lincoln Park will provide necessary reasonable auxiliary aides and services, such as signers for the hearing impaired and audio tapes of printed material being considered at the meeting to individuals with disabilities at the meeting/hearing upon seven (7) days prior notice to the City of Lincoln Park. Individuals with disabilities requiring auxiliary aides or services should contact the City of Lincoln Park by writing or calling the following: The Building Department, 1355 Southfield Road, Lincoln Park MI 48146; 313-386-1800 ext. 1296

CITY OF LINCOLN PARK COUNTY OF WAYNE, STATE OF MICHIGAN PLANNING COMMISSION MEETING OF MARCH 13, 2019

A Planning Commission meeting of March 13, 2019 held at the City of Lincoln Park City Hall, 1355 Southfield Road, Lincoln Park, Michigan.

1. MEETING CALLED TO ORDER:

A. The meeting was called to order at 7:02 P.M.

2. PLEDGE OF ALLEGIANCE:

3. ROLL CALL OF OFFICERS:

PRESENT: Kelsey, Palmer, Horvath, Kissel, Graczyk

ABSENT: Briones

EXCUSED:

ALSO PRESENT: Leah DuMouchel, John Meyers

4. APPROVAL OF MINUTES

A. November 14, 2108

B. January 9, 2109

Minutes approved as written

5. APPROVAL OF AGENDA

Agenda approved with the addition of; Election of Planning Commission Secretary under New Business

6. UNFINISHED BUISNESS:

A. 2019 Annual Training – Checking April availability for planning members. Mike is not available April 17th, Larry is not available the 24th and Kevin is not available the 27th. Adjourned until Matthew Coppler has set a date.

7. NEW BUISNESS

A. Conceptual Review: 26182 Outer Dr – Supportive Housing Apartments

The applicant proposed to build a thirty -two (32) units affordable multifamily rental housing with supportive services to be provided on and off site. Residency will be restricted to individuals and tenants whose income are at or below 60% of the area median income for Wayne County.

The Planning Commission approved a Site Plan and Special Land Use permit for this project in September of 2016. However, the necessary funding for the project was secured through the Michigan State Housing and Development Authority via an extended process that exceeded the period of approval for the Special Land Use and Site Plan. Therefore, the applicant has resubmitted the drawings to the Planning Commission to start the process again.

There are no proposed changes to the site plan since the Planning Commission last approved it, except for a minor boundary change which was approved administratively in March 2017.

This item is adjourned until the April planning meeting

B. Annual Report to City Council

Motion by Kelsey to send annual report to City Council, support by Palmer All present voting Yes, Motion Carried

C. Nomination and Election of Planning Commission Secretary

Congratulations to Krystal Medina for being appointed to the Police and Fire Commission.

There are now three vacant seats on the Planning Commission. Krystal served as Secretary of the Planning Commission and a recommendation for a new Secretary is required.

Mr. Horvath has accepted the nomination as Secretary of the Planning Commission

All present voting Yes, Motion carried unanimously

8. POLICY REVIEW AND DISCUSSION

None

9. REPORTS FROM DEPARTMENTS AND OTHER BOARDS AND COMMISSIONS

None

10. PUBLIC COMMENTS

None

11. COMMENTS FROM PLANNING COMMISSIONERS

Gerald inquired about moving the City Hall location, John Meyers provided there is no information on this project.

Master Plan is in production. Future Land Use is still in the works, and hopefully will be available for the April meeting

12. ADJOURNMENT

Motion by Kelsey to adjourn, support by Graczyk Motion carried unanimously

Meeting adjourned at 7:33 PM	



River's Edge Apartments

Special Land Use Review

Applicant Community Care Services, Susan Kozak

Project River's Edge Apartments

Address 26182 Outer Drive

Date April 10, 2019

Request Special Land Use Approval

Recommendation Approval

REQUEST

The applicant proposes to build a 32-unit supportive housing facility on its property located at 26182 West Outer Drive. The supportive housing facility is intended to serve clients of Community Care Services, which is adjacent to the proposed development and will retain ownership in it. The applicant seeks a Special Land Use approval in accordance with §1282.03(i), "Uses similar to the principal permitted uses of Section 1282.02, Principal Permitted Uses," which in turn permits Senior Housing and Housing for the Elderly.

The Code defines "housing for the elderly" in Section 1260.08 as follows:

HOUSING FOR THE ELDERLY: An institution other than a hospital or hotel which provides room and board to non-transient persons primarily sixty (60) years of age or older. Housing for the elderly may include:

- (1) **Senior Apartments:** Multiple-family dwelling units occupied by persons fifty-five (55) years of age or older.
- (2) **Elderly Housing Complex:** A building or group of buildings containing dwellings where the occupancy is restricted to persons sixty (60) years of age or older or couples where either the husband or wife is sixty (60) years of age or older.
- (3) Congregate or Interim Care Housing: A semi-independent housing facility containing congregate kitchen, dining, and living areas, but with separate sleeping rooms. Such facilities typically provide special support services, such as transportation and limited medical care.
- (4) **Dependent Housing Facilities:** Facilities such as convalescent homes and nursing homes which are designed for older persons who need a wide range of health and support services, including personal nursing care.



The proposed project consists of a housing facility restricted to individuals and tenants whose incomes are at or below 60% of the area median income for Wayne County. It is intended that Community Care Services will work closely with the facility's management to coordinate the housing needs of CCS's clientele with the facility, and for CCS to offer some of its customary outpatient care services on-site at the proposed facility. Because of this relationship, and because the City of Lincoln Park does not define "supportive housing" specifically, this project is considered for the purposes of zoning classification to be similar to housing for the elderly, and thus a use permitted after special approval in the RBD.

CRITERIA FOR REVIEW

The following conditions are all required to be met before a Special Land Use approval may be granted:

- 1) The special use will promote the use of land in a socially and economically desirable manner for persons who will use the proposed land use or activity, for landowners and residents who are adjacent thereto and for the City as a whole;
 - This condition is met.
- 2) The special use is compatible and in accordance with the goals, objectives and policies of the City's Comprehensive Development Plan;
 - This condition is met.
- 3) The special use is necessary for the public convenience at that location;
 - This condition is met.
- 4) The special use is compatible with adjacent uses of land, and can be constructed, operated and maintained so as to continue to be compatible with the existing or intended character of the general vicinity and so as not to change the essential character of the area in which it is proposed;
 - This condition is met.
- 5) The special use is so designed, located and proposed to be operated that the public health, safety and welfare will be protected;
 - This condition is met.
- 6) The special use can be adequately served by public services and facilities without diminishing or adversely affecting public services and facilities to existing land uses in the area;
 - This condition is met.
- 7) The special use will not cause injury to the value of other property in the neighborhood in which it is to be located;
 - This condition is met.
- 8) The special use will protect the natural environment, help conserve natural resources and energy, and will not involve uses, activities, processes, materials and equipment or conditions of operation that will



be detrimental to the natural environment, public health, safety or welfare by reason of excessive production of traffic, noise, smoke, odors or other such nuisance;

This condition is met.

9) The special use is within the provisions of uses requiring special approval as set forth in the various zoning districts herein, is in harmony with the purposes and conforms to the applicable regulations of the zoning district in which it is to be located, and meets applicable site design standards for use in Section 1296.02; and

This condition is met.

10) The special use is related to the valid exercise of the City's police power and purposes which are affected by the proposed use or activity.

This condition is met.

RECOMMENDATION

It is recommended that the Lincoln Park Planning Commission **approve** the Supportive Housing Special Land Use proposed at 26182 West Outer Drive.



River's Edge Apartments

Site Plan Review

Applicant Community Care Services, Susan Kozak

Project River's Edge Apartments

Address 26182 Outer Drive

Date April 10, 2019

Request Site Plan Approval

Recommendation Approve

GENERAL

All elements of the site plan shall be designed to take into account the site's topography, the size and type of plot, the character of adjoining property, and the traffic operations of adjacent streets. The site shall be developed so as not to impede the normal and orderly development or improvement of surrounding property for uses permitted in this Zoning Code. The site plan shall conform with all requirements of this Zoning Code, including those of the applicable zoning district(s).

Project and Site Description

The applicant proposes to build thirty-two (32) units of affordable multifamily rental housing with supportive services to be provided on and off site. Residency will be restricted to individuals and tenants whose incomes are at or below 60% of the area median income for Wayne County. It is intended that Community Care Services will work closely with the facility's management to coordinate the housing needs of CCS's clientele with the facility, and for CCS to offer some of its customary outpatient care services on-site at the proposed facility. These services are intended to enhance the residents' ability to maintain independent living, and will address the unique needs of each resident.

This project received Site Plan Approval and Special Land Use Approval in September of 2016. However, those approvals expired before project funding was secured.

Site conditions

Figure 1: Aerial View





The property is a vacant parcel which is owned by and adjacent to Community Care Services' property at 28164 West Outer Drive. It is on the northern edge of the City, separated from the City of Detroit by Outer Drive. The northern branch of the Ecorse River flows to the south of CCS' current building, and the subject site's southwest corner is adjacent to the 100-year floodplain. The sole change that has occurred to the plans since they were approved in 2016 was a boundary adjustment which removed the subject site from the floodplain (both sides of the boundary line are owned by CCS).



Figure 2: Flood Zone

Master Plan

Future Land Use Classification

The site is intended for Office / Medical future land use.

Intent; Desirable Uses and Elements

The intent of this district is to locate professional offices and larger medical facilities, including health centers and hospitals, along major thoroughfares to ensure ready access for all City residents. Limited commercial uses that complement and have minimal impact on the primary office uses are also appropriate. Office / Medical uses should provide for pedestrian circulation and public transportation facilities.



Land Use and Zoning

Zoning

The site is zoned Regional Business District (RBD).

Figure 3: Zoning Map



Per Section 1282.02 of the Lincoln Park Zoning Code, senior housing and housing for the elderly is a principal permitted use in the RBD, and Section 1282.03 of the Code permits after special approval uses which are similar to principal permitted uses. The Code defines "housing for the elderly" in Section 1260.08 as follows:

HOUSING FOR THE ELDERLY: An institution other than a hospital or hotel which provides room and board to non-transient persons primarily sixty (60) years of age or older. Housing for the elderly may include:

- (1) **Senior Apartments:** Multiple-family dwelling units occupied by persons fifty-five (55) years of age or older.
- (2) **Elderly Housing Complex:** A building or group of buildings containing dwellings where the occupancy is restricted to persons sixty (60) years of age or older or couples where either the husband or wife is sixty (60) years of age or older.
- (3) Congregate or Interim Care Housing: A semi-independent housing facility containing congregate kitchen, dining, and living areas, but with separate sleeping rooms. Such facilities typically provide special support services, such as transportation and limited medical care.
- (4) **Dependent Housing Facilities:** Facilities such as convalescent homes and nursing homes which are designed for older persons who need a wide range of health and support services, including personal nursing care.

The proposed project consists of a housing facility restricted to individuals and tenants whose incomes are at or below 60% of the area median income for Wayne County. It is intended that Community Care Services will work closely with the facility's management to coordinate the housing needs of CCS's



clientele with the facility, and for CCS to offer some of its customary outpatient care services on-site at the proposed facility. Because of this relationship, and because the City of Lincoln Park does not define "supportive housing" specifically, this project is considered for the purposes of zoning classification to be similar to housing for the elderly, and thus a use permitted after special approval in the RBD.

Proposed and Existing Uses

Site: Supportive housing North: ROW, City of Detroit

East: Medical

South: Community Care Services (same ownership)

West: Electrical transmission easement

Dimensional Standards

The dimensional requirements of the RBD district are described in the chart below. (§1294.32, except where noted.)

	Required	Provided	Compliance
Lot Width	40'	286′	Met
Street Frontage (§1294.09)	Shrubbery and low retaining walls 2 ½' < height < 8'		Met
Lot Area	4000 sf in RBD; 2000 sf per dwelling unit used to calculate (MFRD standard) = 64,000 sf	66,495 sf	Met
Lot Coverage	50%	17,475 / 66,495 = 26%	Met
Height	2 stories or 25'	25' plus parapet	Met
Setback – Front	30'	30'	Met
Setback – Sides	10' least; 20' total	30', 30' = 60' total	Met
Setback – Rear	25'	27'	Met

Items to be addressed

None

BUILDING DESIGN

The building design shall relate to the surrounding environment in regard to texture, scale, mass, proportion, and color. High standards of construction and quality materials will be incorporated into the new development. In addition to following design guidelines adopted in specific district or sub-area plans, the building design shall meet the requirements of Section 1296.04, Standards for Architecture and Building Materials.



	Required	Compliance
Building mass, height within 500'	nt, bulk and width-to-height ratio within 50-150% of buildings	Met
 Architectural variety 		Met
Similar materials and	d entrances to buildings within 500'	
masonry block, stor districts, 50% if faci	orimarily natural products conveying permanence (brick, decorative ne, or beveled wood siding) = 75% of each façade (industrial ing ROW) exterior insulation finish systems (EIFS), vinyl, aluminum, or steel	Met
siding; or similar syr public streets or free	othetic or highly-reflective materials (industrial districts not facing seways, these and pre-cast concrete or plain masonry block) nt for decorative features only)	
Façade: <100' unint	terrupted	Met
detailed trim, brick	off-sets, angular forms, arches, colonnades, columns, pilasters, bands, contrasting courses of material, cornices or porches	
All sides similar		
	recessed, visually-obvious sills and one columns, mullions, or material found elsewhere on the	Met
• Front facades > 25%		
 Size, shape, orienta 	tion, spacing to match buildings within 500'	
Main entrances: doo		Met
	erhangs, recesses, peaked roof forms, porches, arches, canopies, display windows, accent colors, tile work, moldings, pedestrian-scale door pulls)	
Pitched / shingled ro		Met
	with slope of 0.5 to 1	
	oof forms, parapets, cornice lines	
Roof-top mechanica	al equipment screened by roof form.	

Items to be addressed

None

PRESERVATION OF SIGNIFICANT NATURAL FEATURES

Judicious effort shall be used to preserve the integrity of the land, existing topography, and natural, historical, and architectural features as deemed in this Zoning Code, in particular flood hazard areas and wetlands designated/regulated by the Michigan Department of Environmental Quality, and, to a lesser extent, flood hazard areas and wetlands which are not regulated by the Department.

A portion of the site was originally within the 100-year floodplain. The boundary has been adjusted to remove the floodplain from the site.

Items to be addressed

None



SIDEWALKS, PEDESTRIAN AND BICYCLE CIRCULATION

The arrangement of public or common ways for vehicular and pedestrian circulation shall be connected to existing or planned streets and sidewalks/ pedestrian or bicycle pathways in the area. There shall be provided a pedestrian circulation system which is separated from the vehicular circulation system. In order to ensure public safety, special pedestrian measures, such as crosswalks, crossing signals and other such facilities may be required in the vicinity of primary and secondary schools, playgrounds, local shopping areas, fast food/ service restaurants and other uses which generate a considerable amount of pedestrian or bicycle traffic.

Sidewalks are provided throughout the project site. A separated pedestrian circulation system connects the proposed project to the parking lot, the service drive, public rights-of-way at Outer Drive and Chandler Avenue, and Community Care Services' existing property at 26184 West Outer Drive. The sidewalk along Outer Drive also serves as a connection to the SMART transit system, hosting a stop for route 125 Fort Street / Eureka.

Items to be addressed

None

PARKING

The number and dimensions of off-street parking [spaces] shall be sufficient to meet the minimum required by this Zoning Code. However, where warranted by overlapping or shared parking arrangements, the Planning Commission may reduce the required number of parking spaces, as provided in this Zoning Code.

Use	Required	Proposed	Compliance
Supportive housing	Senior citizen housing: One for every two dwelling units = 32/2 = 17 (max 21)	21	Met
	Convalescent homes: One for every three beds or two rooms plus one for each employee on duty = 20 (max 25)		

Items to be addressed

None

BARRIER-FREE ACCESS

The site has been designed to provide barrier-free parking and pedestrian circulation.



Required	Required Barrier-	Proposed Barrier-	Compliance
Spaces	Free Spaces	Free Spaces	
>25	1	0	Not met

Items to be addressed

□ Applicant to label and identify at least one barrier-free parking space

LOADING

All loading and unloading areas and outside storage areas, including refuse storage stations, shall be screened in accordance with this Zoning Code.

Gross Floor	Loading Spaces –	Loading Spaces –	Compliance
Area	Required	Provided	
17,475	1	1	Met

Items to be addressed

None

ACCESS, DRIVEWAYS, AND VEHICULAR CIRCULATION

Safe, convenient, uncongested, and well-defined vehicular and pedestrian circulation within and to the site shall be provided. Drives, streets, parking and other elements shall be designed to discourage through traffic, while promoting safe and efficient traffic operations within the site and at its access points. All driveways shall meet the design and construction standards of the City. Access to the site shall be designed to minimize conflicts with traffic on adjacent streets, particularly left turns into and from the site. For uses having frontage and/or access on a major traffic route, as defined in the City of Lincoln Park Comprehensive Development Plan, the number, design, and location of access driveways and other provisions for vehicular circulation shall comply with the provisions of Section 1290.10, Access Management Standards.

Outer Drive is identified in §1290.10 as a major traffic route to which the access management and driveway standards in that section apply.

Required	Provided	Compliance
 Single two-way driveway or pair of one-way driveways Two-way: 25' < throat width < 30' (face to face of curb). One-way paired: each 20' measured perpendicularly. May be separated by 10' median; sidewalks shall be continued or maintained 25' radii; 30' radii where daily truck traffic expected Corner lots: one access point per street with >100' frontage 	The site is accessed via an access road from Outer Drive. A pair of two-way driveways leads from the access drive into the parking lot.	Met



 If frontage >300' and documented need (ITE), may allow additional access with design restrictions If frontage >600', max of 3 drives may be allowed; one with design restrictions 		
 Shared access: driveways along property lines, connecting parking lots, on-site frontage roads, rear service drives. Encouraged and may be required for sites within 1/4 mile of major intersections; having dual frontage; with <300' frontage; with sight distance problems; along congested or accident-prone roadway segments Connection to adjacent facilities may be required; site accommodation may be required for future connection to undeveloped adjacent property Letters of agreement or access easements required 	No shared access arrangements are proposed, and connection to adjacent facilities is limited to the sidewalk along Chandler Ave. Considering the uniform ownership of, and proposed relationship between, the existing CCS property and the subject site, it is recommended that the applicant consider these opportunities.	Met
 Triangular unobstructed view areas: from corner of two ROWs, 25' along each; from corner of ROW and driveway, 10' along driveway and 5' along ROW Grass / groundcover only in 3' strip abutting driveway and ROW Trees permitted if trimmed between 30" and 6' from 	Groundcover and trees are proposed in the triangular unobstructed view areas.	Met
 ground level May require drive to be located on the far side of the property from congested intersections >150' from signalized intersection or 4-way stop, or right-turn-only at 75' from intersection >100' otherwise >200' from centerline of I-75 access ramps 	N/A	N/A
 Same side of street: Driveway spacing determined by speed limits in §1290.10 Across the street: Driveways directly aligned or >150' offset (excludes right-turn-only) Directional driveways, divided driveways, and deceleration tapers and/or by-pass lanes may be required by the Planning Commission where they will reduce congestion and accident potential 	N/A	N/A

Items to be addressed

None

EMERGENCY VEHICLE ACCESS

All buildings or groups of buildings shall be arranged so as to permit necessary emergency vehicle access as required by the Fire Department and Police Department.



This item is subject to review by the Lincoln Park Fire and Police Departments.

Items to be addressed

☐ Emergency vehicle access is subject to Fire and Police Department review

STREETS

All streets shall be developed in accordance with the City of Lincoln Park Subdivision Control Ordinance and construction standards, unless developed as a private road in accordance with the requirements of the City.

No new streets are proposed.

Items to be addressed

None

LANDSCAPING, SCREENING, AND OPEN SPACE

The landscape shall be preserved in its natural state, insofar as practical, by removing only those areas of vegetation or making those alterations to the topography which are reasonably necessary to develop the site in accordance with the requirements of this Zoning Code. Landscaping shall be preserved and/or provided to ensure that proposed uses will be adequately buffered from one another and from surrounding public and private property. Landscaping, landscape buffers, greenbelts, fencing, walls and other protective barriers shall be provided and designed in accordance with the provisions of Section 1296.03, Landscaping Standards. Recreation and open space areas shall be provided in all multiple-family residential and educational developments.

	Required	Proposed	Compliance
9	Greenbelt, 10' width minimum with	14' - 30' greenbelt	Met
Street Landscaping	groundcover		
łsca	1 tree and 4 shrubs per 40' of street frontage	19 trees; 78 shrubs	Met
anc	769' total = 19 trees and 76 shrubs		
et L	Where headlights from parked vehicles will	N/A	N/A
tre	shine into the ROW, may require a totally		
\sim	obscuring hedge		
	10% of total lot area landscaped, including	17,250 sf	Met
Jing	groundcover		
scap	(66,495 sf *0.1) = 6650 sf landscaping		
pu	Interior landscaping to be grouped near		Met
r Lā	entrances, foundations, walkways, service areas		
Interior Landscaping	1 tree per 400 sf of required landscaping and 1	17 trees; 54 shrubs	Met
Inte	shrub per 125 sf of required landscaping		
	66,475 sf = 17 trees and 53 shrubs		
in	1 deciduous or ornamental tree per 10 parking	2 trees	Met
Parkin g Lot	spaces		
3	20/10 = 2		



	Required	Proposed	Compliance
	100 sf of planting area per tree		Met
Screening	Waste receptacle: Decorative masonry wall of at least 6' with solid or impervious gate	6' masonry wall	Met

None

SOIL EROSION CONTROL

The site shall have adequate lateral support so as to ensure that there will be no erosion of soil or other material. The final determination as to adequacy of, or need for, lateral support shall be made by the Building Superintendent or City Engineer.

Soil erosion controls are subject to detailed engineering review. A Soil Erosion and Sedimentation permit must be obtained from Wayne County.

Items to be addressed

Soil erosion controls shall be addressed in detailed engineering review.
Soil Erosion and Sedimentation permit shall be obtained from Wayne County.

UTILITIES

Public water and sewer facilities shall be available or shall be provided for by the developer as part of the site development, where such systems are available.

Public water and sewer facilities are available to the development. Utility installation is subject to detailed engineering review.

Items to be addressed

Utility installation shall be addressed in detailed engineering review.

STORMWATER MANAGEMENT

Appropriate measures shall be taken to ensure that removal of surface waters will not adversely affect neighboring properties or the public storm drainage system. Provisions shall be made to accommodate stormwater which complements the natural drainage patterns and wetlands, prevent erosion and the formation of dust. Sharing of stormwater facilities with adjacent properties shall be



encouraged. The use of detention/ retention ponds may be required. Surface water on all paved areas shall be collected at intervals so that it will not obstruct the flow of vehicular or pedestrian traffic or create standing water.

Stormwater management is subject to detailed engineering review; preliminary comments are appended to this report. The storm sewer system is under the jurisdiction of Wayne County; required permits must be secured.

secu	red.
Item	ns to be addressed
	Stormwater management shall be addressed in detailed engineering review. Applicant shall provide required Wayne County Drain Commission permitting documents.
Exteri	HTING ior lighting shall be arranged so that it is deflected away from adjacent properties and so that it does not impede the vision of c along adjacent streets. Flashing or intermittent lights shall not be permitted.
Exte	rior lighting is not expected to impede the vision of traffic along adjacent streets.
Item	ns to be addressed
Non	e
	SE ite has been designed, buildings so arranged, and activities/equipment programmed to minimize the emission of noise, cularly for sites adjacent to residential districts.

Noise impacts associated with the proposed use are expected to be minimal.

Items to be addressed

None

MECHANICAL EQUIPMENT

Mechanical equipment, both roof and ground mounted, shall be screened in accordance with the requirements of this Zoning Code.

All proposed mechanical equipment is screened.

Items to be addressed

None

planning review



SIGNS

The standards of the City's Sign Code are met.

Signange is subject to Building Department review.

Items to be addressed

□ Signage shall be permitted by the Building Department in accordance with Chapter 1476 of the City Code.

HAZARDOUS MATERIALS OR WASTE

For businesses utilizing, storing or handling hazardous material such as automobile service and automobile repair stations, dry cleaning plants, metal plating industries, and other industrial uses, documentation of compliance with state and federal requirements shall be provided.

No hazardous materials are expected.

Items to be addressed

None

OTHER AGENCY REVIEWS

The applicant has provided documentation of compliance with other appropriate agency review standards, including, but not limited to, the Michigan Department of Natural Resources, Michigan Department of Environmental Quality, Michigan Department of Transportation, Wayne County Drain Commission, Wayne County Health Department, and other federal and state agencies, as applicable.

Items to be addressed

None

VARIANCES

No variances are requested.

Items to be addressed

None



RECOMMENDATIONS

Findings

The application is in substantial compliance with §1296, Site Plan Review.

Conditions

Applicant to label and identify at least one barrier-free parking space
Soil erosion controls shall be addressed in detailed engineering review.
Soil Erosion and Sedimentation permit shall be obtained from Wayne County.
Utility installation shall be addressed in detailed engineering review.
Stormwater management shall be addressed in detailed engineering review.
Applicant shall provide required Wayne County Drain Commission permitting documents.
Signage shall be permitted by the Building Department in accordance with Chapter 1476 of the City
Code.

Recommendations

It is recommended that the Planning Commission **approve** the Site Plan submission for Rivers Edge Apartments, 26182 West Outer Drive, with the conditions noted herein.

RIVERS EDGE APARTMENTS

LINCOLN PARK

LIST OF DRAWINGS

CIVIL ENGINEERING

BOUNDARY AND TOPOGRAPHIC SURVEY

PAVING AND GRADING PLAN

UTILITY PLAN SOIL EROSION CONTROL

L.101 SITE PLANTING PLAN L.102 PLANT LIST AND DETAILS

L.103 SITE DETAILS

LANDSCAPING

ARCHITECTURAL

A.S.101 ARCHITECTURAL SITE PLAN A.101 FIRST / SECOND FLOOR PLAN A.201 EXTERIOR ELEVATIONS

ELECTRICAL

E.101 SITE PHOTOMETRIC PLAN

DEVELOPMENT TEAM

OWNER

COMMUNITY CARE SERVICES 26184 W. OUTER DRIVE LINCOLN PARK, MI 48146 (313) 389-7546

ARCHITECT

FUSCO, SHAFFER & PAPPAS, INC. **550 NINE MILE ROAD** FERNDALE, MICHIGAN 48220 (248) 543.4100

LANDSCAPE ARCHITECT

KENNETH WEIKAL LANDSCAPE ARCHITECTURE **33203 BIDDESTONE** FARMINGTON HILLS, MI 48334-4313 (248) 477-3600

CIVIL ENGINEER

GEORGE JEROME & CO. **28304 HAYES ROSEVILLE, MI 48066** (586)774-3000

DATE ISSUE 08.24.2016 **SPA SUBMISSION** 03.27.2017 **BOUNDARY REVISION** 03.19.2018 **SPA RESUBMISSION** 03.19.2019 SPA RESUBMISSION

SIGNATURE BLOCK

	SIGNATURE	INITIALS	DATE
OWNER			
ARCHITECT			
GENERAL CONTRACTOR			
SURETY COMPANY			



MICHIGAN

SUMMARY TABLE

NOTE THAT ALL INTENSITY AND DIMENSIONAL DATA NOTED AS "REQUIRED" OR "ALLOWABLE IS BASED ON RBD ZONING STANDARDS

LOT SIZE REQUIRED (MINIMUM) (2,000 SF/UNIT PER MFRD STANDARDS)

64,000 OR 1.46 ACRES

ZONING

64,333 OR 1.47 ACRES RBD - (REGIONAL BUSNIESS DISTRICT)

SITE DENSITY (D.U./ACRE) ALLOWABLE

(2,000 SF/UNIT PER

21.79 DU/ACRE

MFRD LAND/UNIT) PROPOSED LOT COVERAGE ALLOWABLE

21.77 DU/ACRE 50% 27%

1.50

6,433 SF

17,250 SF

20 SPACES

FLOOR AREA RATIO ALLOWABLE (GROSS BUILDING AREA/GROSS SITE AREA)

(35,200/68,183 SF) LANDSCAPE AREA REQUIRED (10% OF SITE AREA)

PROPOSED PARKING

16 SPACES SENIOR CITIZEN HOUSING - ONE FOR EVERY TWO DWELLING UNITS - 32/2 = 16 (20 MAX)

PROVIDED 18 OPEN SPACES PLUS 2 BARRIER FREE)

BUILDING DATA

BUILDING FOOTPRINT

17,600 SF GROSS BUILDING AREA 17,600 SF

1ST FLOOR

2ND FLOOR 17,600 SF TOTAL 35,200 SF 1,100 SF GROSS BUILDING AREA PER UNIT

35,200/32 UNITS

BUILDING HEIGHT ALLOWABLE PROPOSED

UNIT COUNT/MIX

1 BEDROOM UNITS (725 SF)

25' - 0" (2 STORIES) 25' - 0" (2 STORIES)

32 UNITS

NOTES REGARDING NON-APPLICABLE ITEMS:--

PROPOSED BUILDING USE IS 32 UNITS OF SUPPORTIVE HOUSING.


1. (X) NO OUTDOOR STORAGE WILL BE PROVIDED ON SITE.


4. (H) NO HAZARDOUS AND POLLUTING MATERIALS WILL BE USED OR STORED

4. (1) NO HAZARDOUS SUBSTANCES WILL BE STORED, USED, RECYCYLED OR DISPOSED OF ON SITE. NEITHER INSIDE OR OUTSIDE. (KEEP IN MECH./STORAGE.)

4. (J) NO UNDERGROUND STORAGE TANKS EXIST ON THE SITE OR ARE PROPOSED.


4. (K) NO KNOWN CONTAMINATED AREAS EXIST ON SITE PER SURVEY WORK, AND SITE INVESTIGATION.

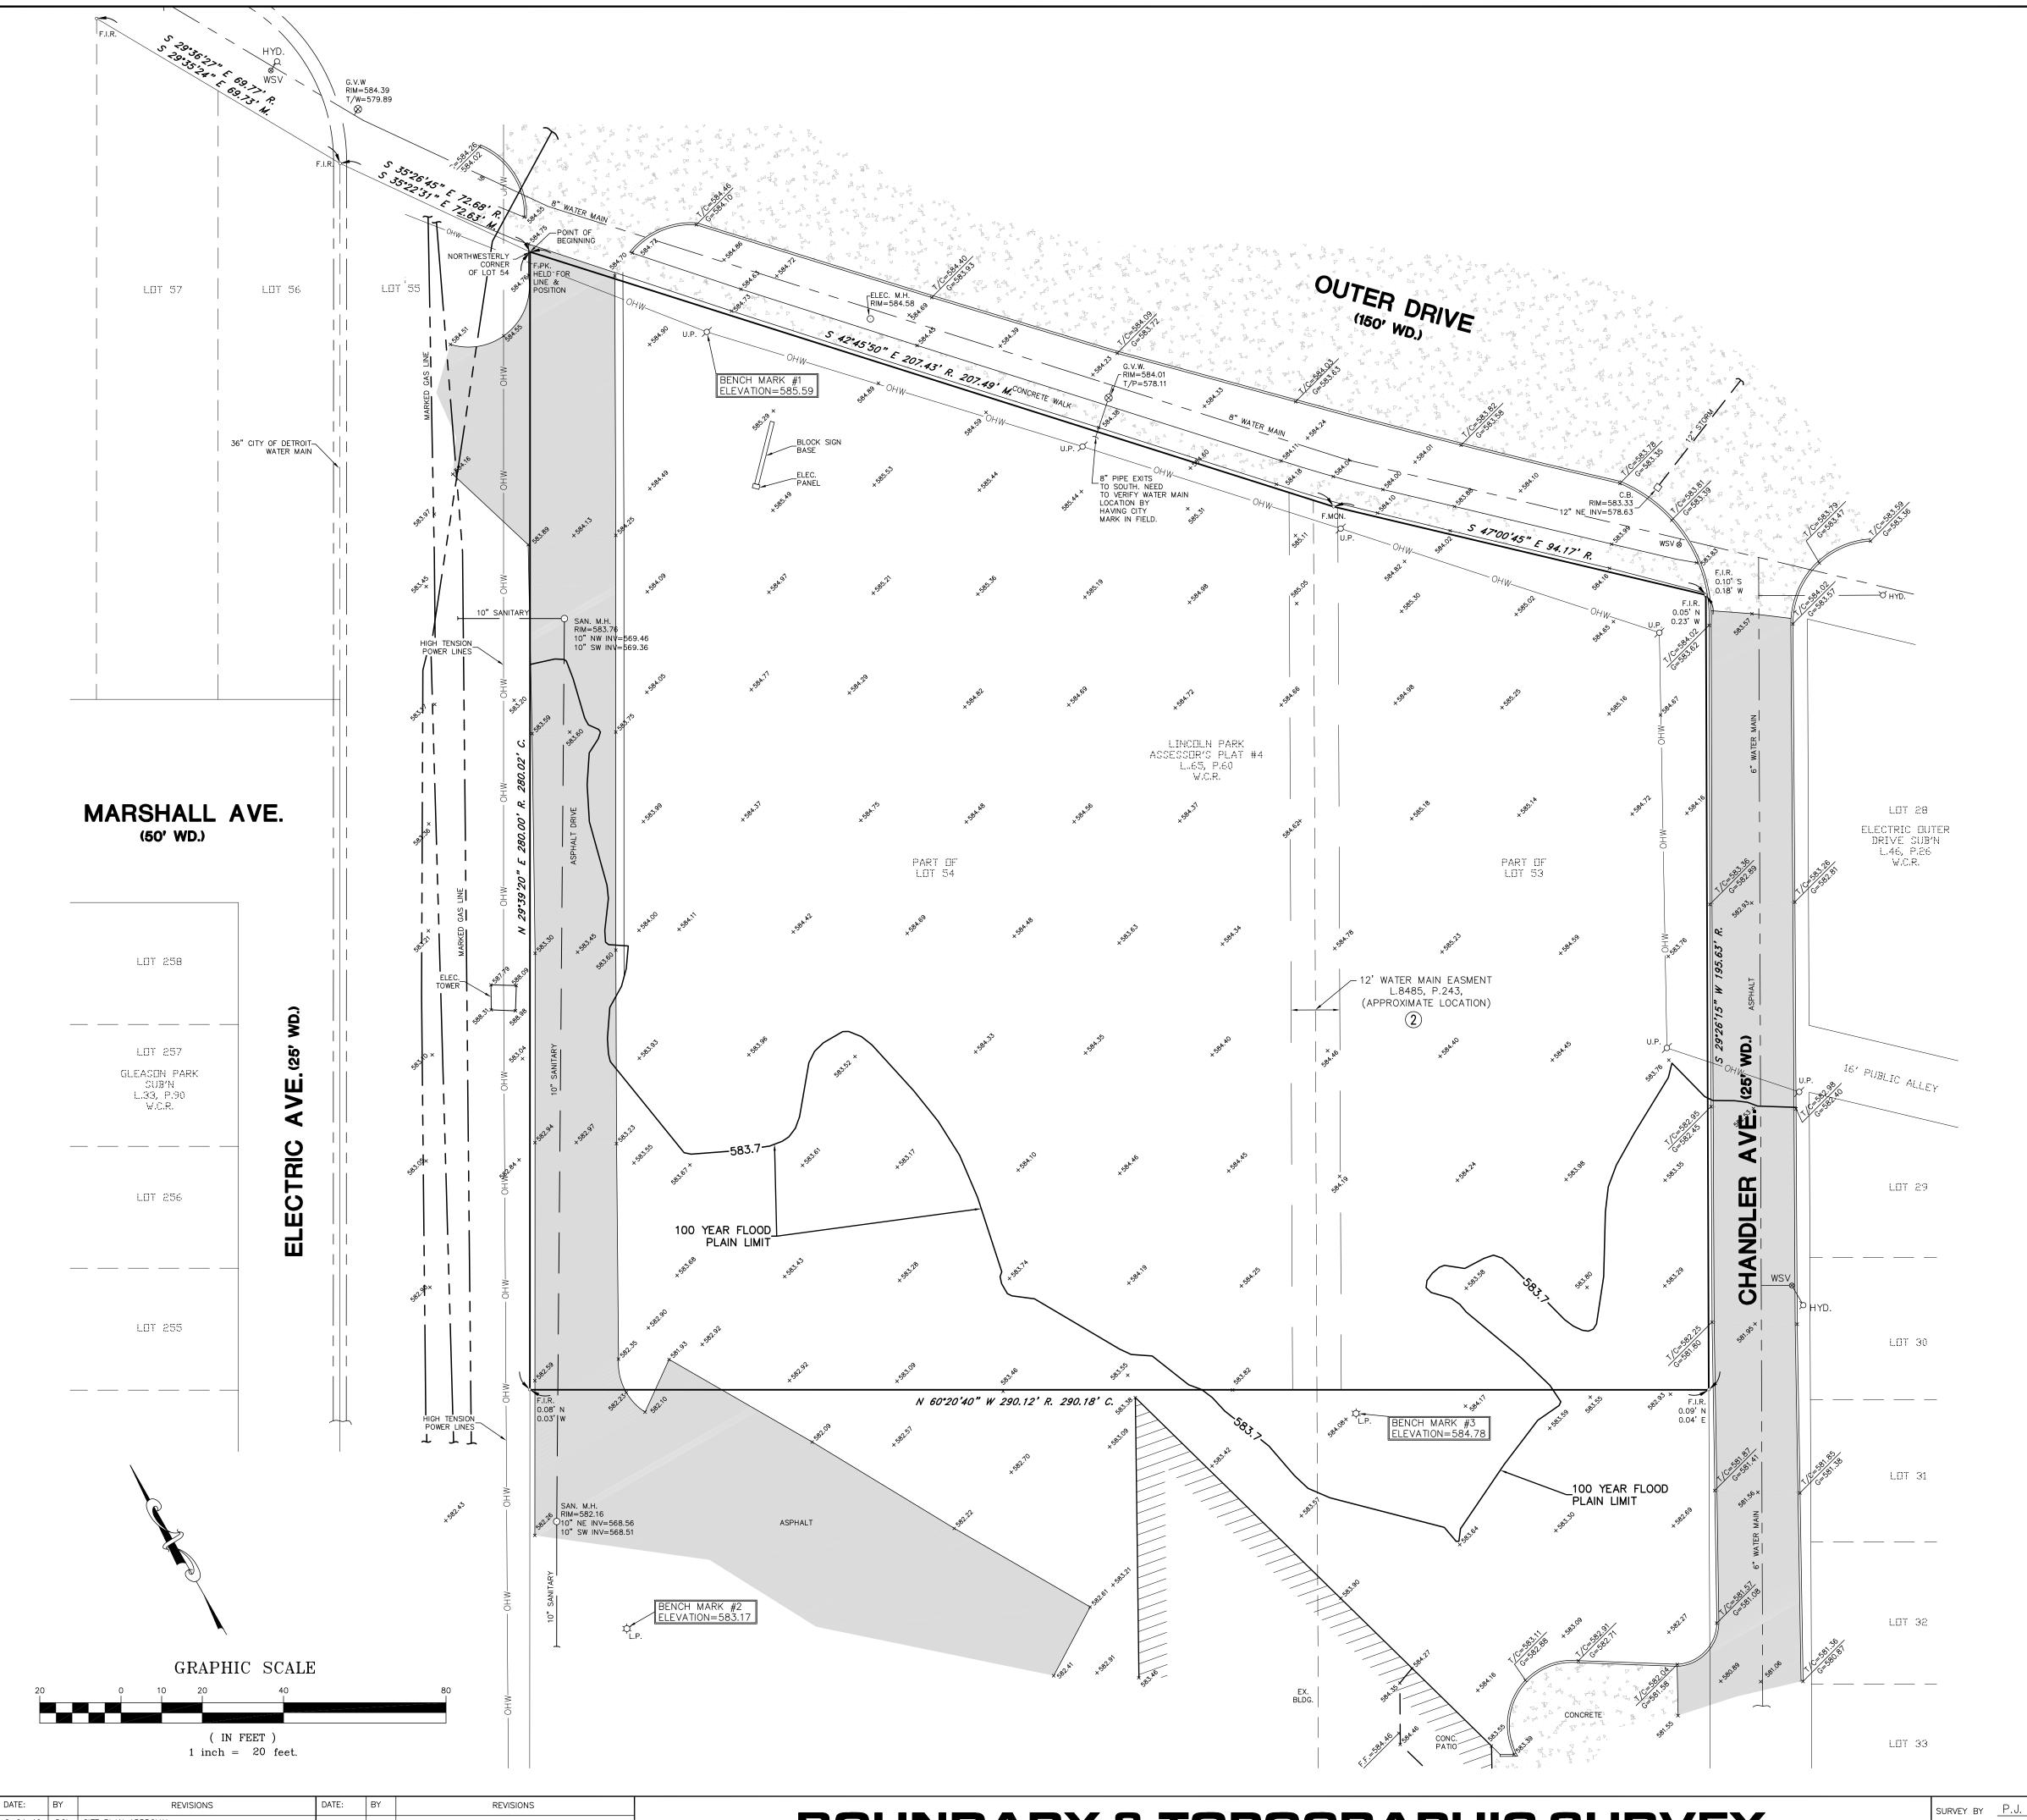

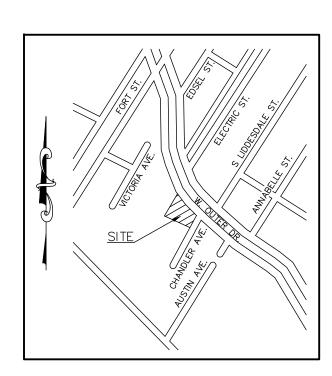

LOCATION MAP
NOT TO SCALE

LEGEND

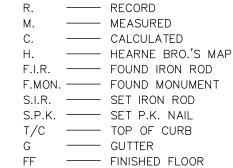

T/W --- TOP OF WALL T/P — TOP OF PIPE □ C.B. — CATCH BASIN Ø U.P. — UTILITY POLE

O M.H. — MANHOLE o c.o. — CLEAN OUT ⊗GVW — GATE VALVE AND WELL ⊗WSV — WATER STOP VALVE QHYD. — FIRE HYDRANT

• S.P. — STEEL POST O M.W. — MONITORING WELL - SIGN ← G.W. — GUY WIRE

———— SANITARY/COMBINED SEWER OVERHEAD UTILITY LINES

SITE BENCHMARKS:

DISC ON SE FACE OF 2ND COLUMN W OF NE'LY MOST COLUMNS N OD C OUTER DR & E OF C I-75 ELEV:589.24 (NAVD 88)

R/R SPIKE IN S FACE OF UTILITY POLE W OF OUTER DR R.O.W. & 50' E'LY OF HIGH TENSION POWER LINES

SITE BENCHMARK # 2
PK NAIL N SIDE CONC. LIGHT POLE BASE 50' S & 25' E OF SW PROPERTY CORNER

ELEV:583.17 (NAVD 88)

SITE BENCHMARK#3 PK NAIL N. SIDE CONC. LIGHT POLE BASE 86' W & 6' S OF SE PROPERTY CORNER ELEV:584.78 (NAVD 88)

SCHEDULE B EXCEPTIONS

- Permanent Water Main Easement recorded in Liber 48984 Page 629, Wayne County Records. Easement location is approximate, as exact location of water main is not known.
- Pipeline Easement recorded in Liber 8485 Page 243, Wayne County Records. Easement is not sufficiently described and therefore is not plotted hereron.
- Declaration and Grant of Cross Easements for Ingress and Egress recorded in Liber 23345 Page 548, Wayne County Records. Easement is blanket in nature and therefore is not plotted hereon.
- Terms and conditions of The Amended Urban Renewal Plan recorded in Liber 19755, 106, Wayne County Records. Easement is blanket in nature and therfore is not plotted hereon.

LEGAL DESCRIPTION (Old Republic National Title Insurance Company Commitment No: 701109, Dated April 5, 2016)

Land in the City of Lincoln Park, County of Wayne, State of Michigan, described as follows:

That part of Lots 53 and 54, "LINCOLN PARK ASSESSOR'S PLAT NO. 4", according to the plat thereof as recorded in Liber 65 of Plats, Page 60, Wayne County Records, described as beginning at the Northwesterly corner of Lot 54; thence South 42 degrees 45 minutes 05 seconds East 207.43 feet; thence South 47 degrees 00 minutes 45 seconds East 94.17 feet; thence South 29 degrees 26 minutes 15 seconds West 195.63 feet; thence North 60 degrees 20 minutes 40 seconds West 290.12 feet; thence North 29 degrees 39 minutes 20 seconds East 280.00 feet to the point of beginning.

BOUNDARY CERTIFICATION

George Jerome & Co. hereby certifies to Community Care Services that it has surveyed the above described property, description furnished by you, for the purpose of establishing outline boundaries, and that the boundaries and corners of said property are as

George G. Jerome Jr., P.S. P.E. 46672


RIVERS EDGE APARTMENTS

8-24-16 DCL SITE PLAN APPROVAL 3-19-18 DCL SITE PLAN APPROVAL RESUBMISSION SITE PLAN APPROVAL RESUBMISSION


BOUNDARY & TOPOGRAPHIC SURVEY PART OF LOTS 53 & 54, LINCOLN PARK ASSESSOR'S PLAT #4, CITY OF LINCOLN PARK, WAYNE COUNTY, MICHIGAN

GEORGE JEROME & CO. D.J.C. CONSULTING MUNICIPAL & CIVIL ENGINEERS • SURVEYORS CHECKED BY G.J.JR. scale 1"= 20' | FOR COMMUNITY CARE | DATE 4-5-16 APPROVED BY G.J.JR.

FIELD BOOK 1410 Pgs.1-3 ROSEVILLE, MI 48066 (586) 774-3000 DRAWING FILE NO. _

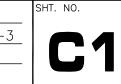



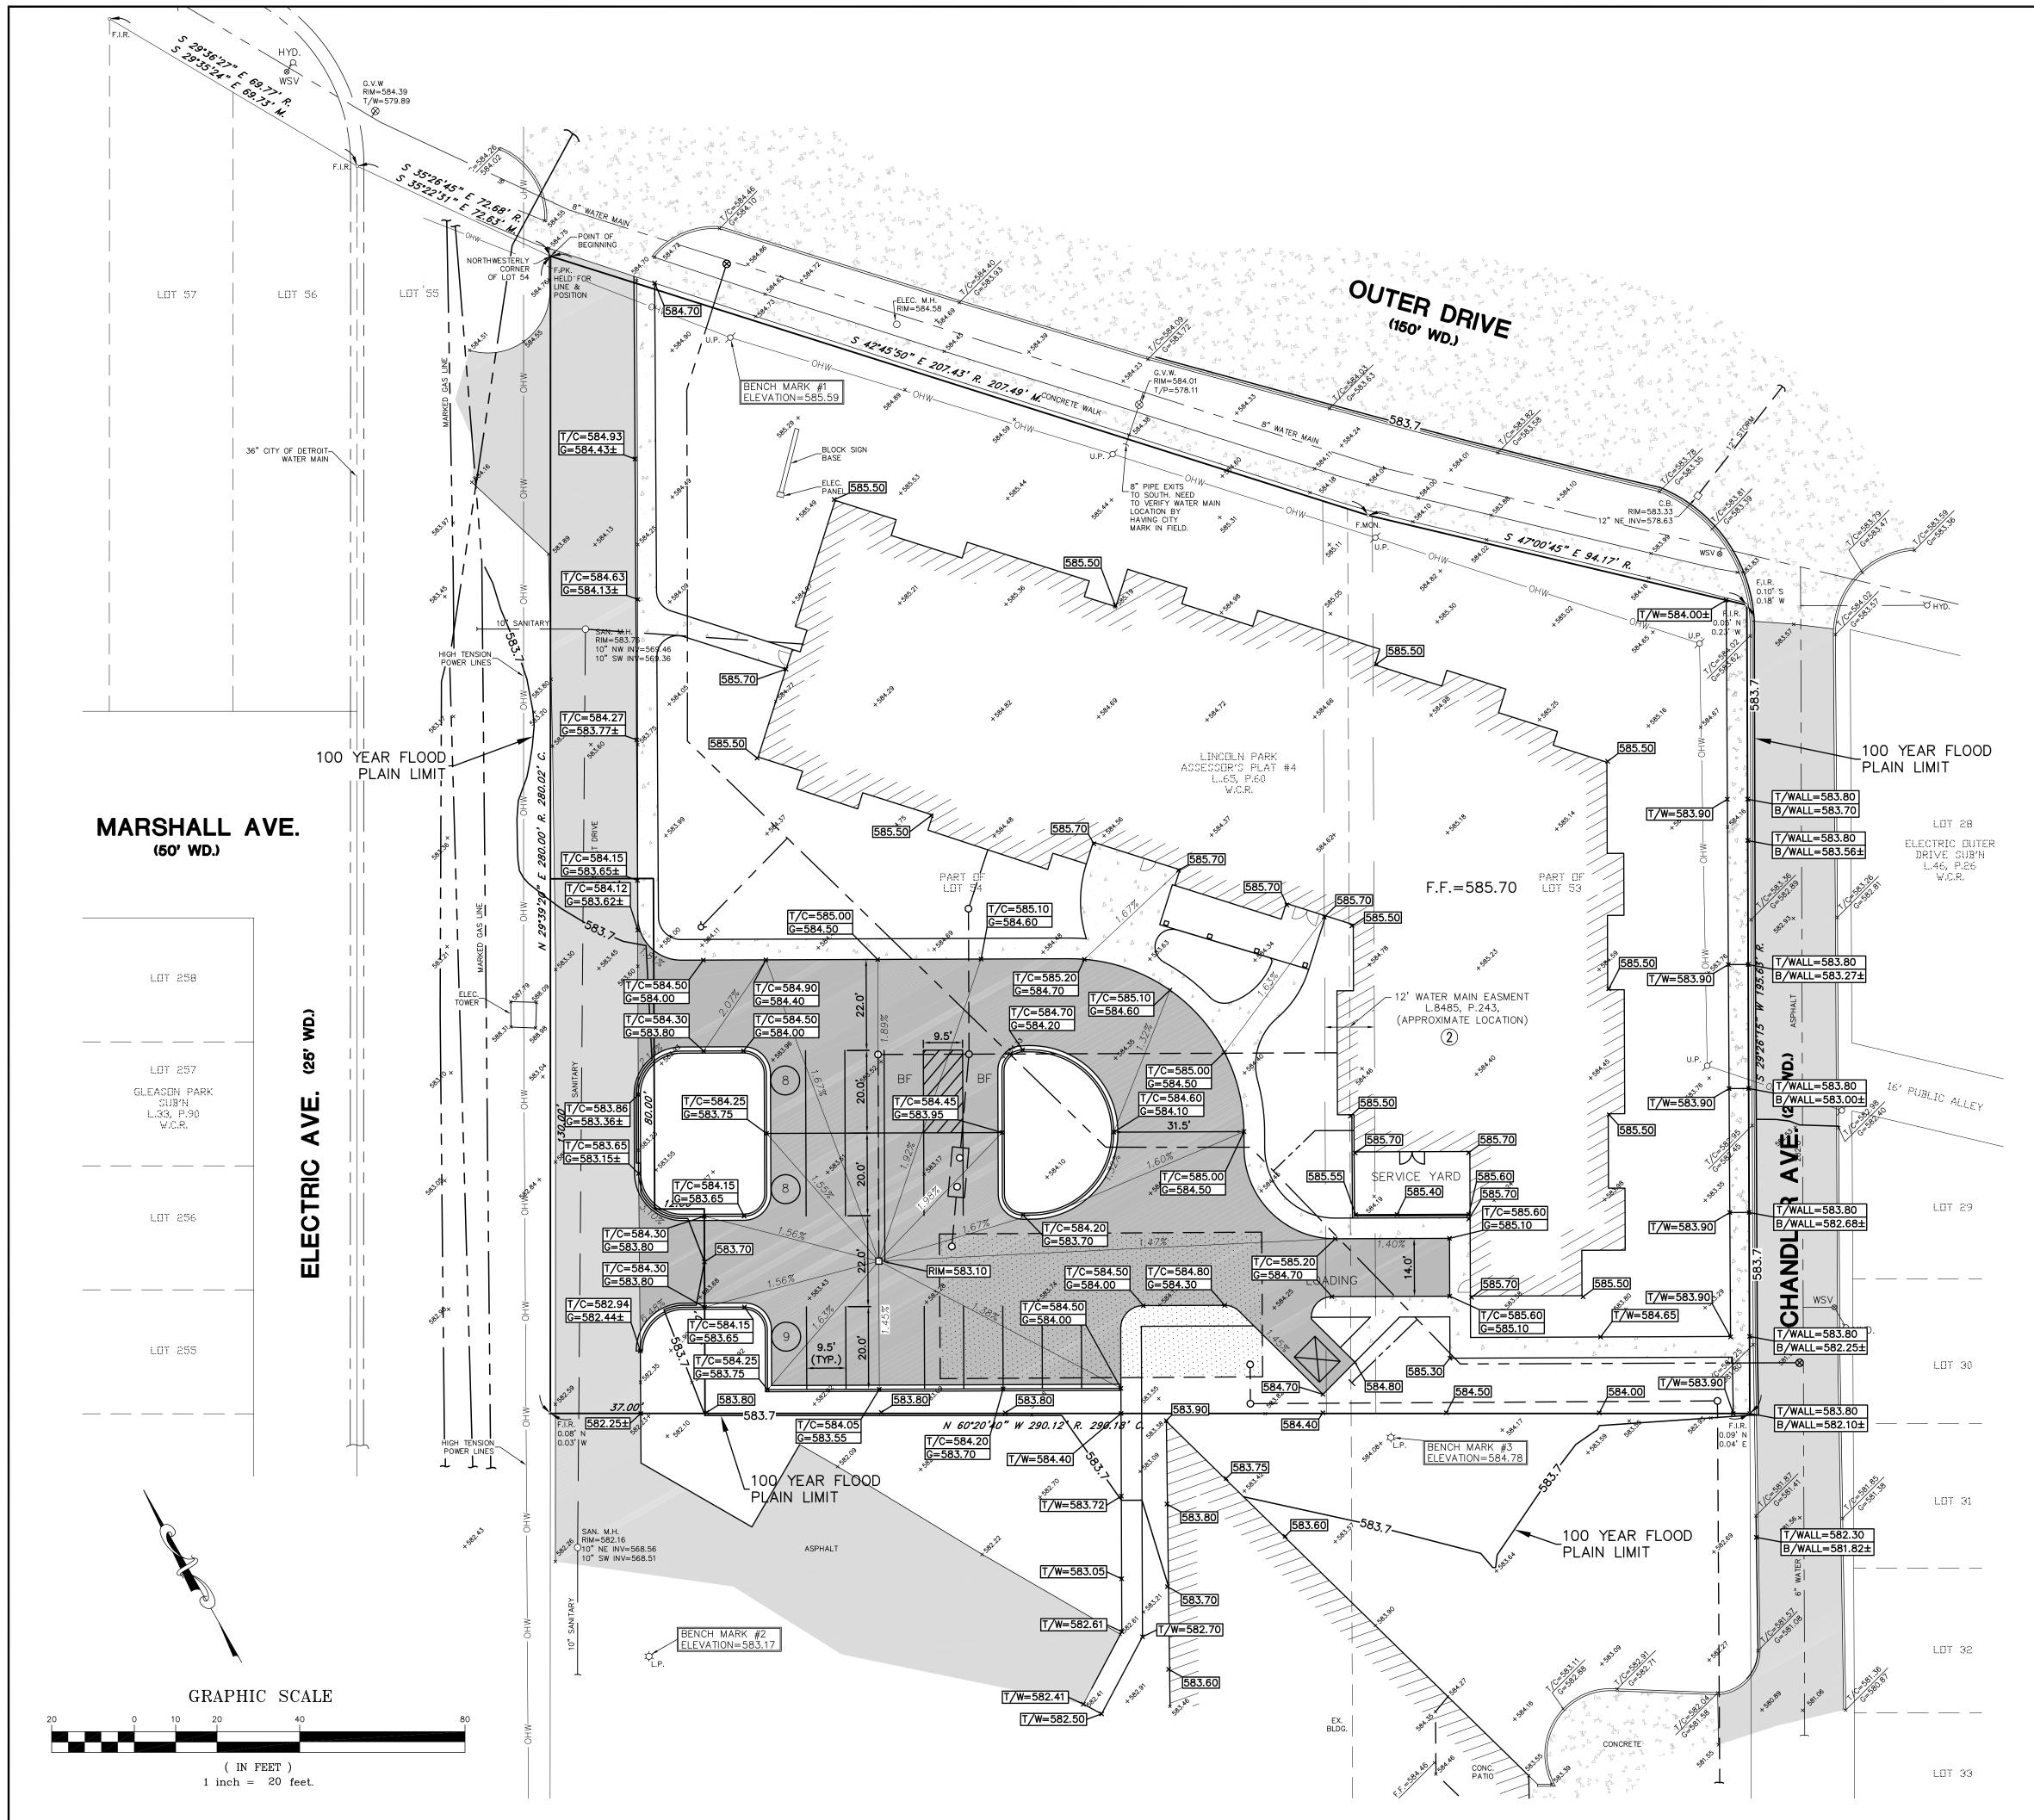


REVISIONS

8-24-16 DCL SITE PLAN APPROVAL

3-19-18 | DCL | SITE PLAN APPROVAL RESUBMISSION

SITE PLAN APPROVAL RESUBMISSION

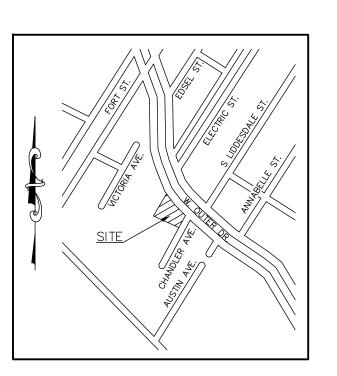

LOCATION MAP
NOT TO SCALE

LEGEND

H. F.I.R. F.MON. S.I.R. S.P.K. T/C G FF T/W T/P C.B. JU.P. O M.H. O C.O. SGVW WSV AHYD. HYD. S.P.	CALCULATE HEARNE BE FOUND IROI FOUND MON SET IRON E SET P.K. N TOP OF CU GUTTER FINISHED FI TOP OF WA TOP OF PIE CATCH BAS UTILITY POLE MANHOLE CLEAN OUT LIGHT POLE GATE VALV WATER STO FIRE HYDRA STEEL POS	RO.'S MAP N ROD NUMENT ROD AIL PRB LOOR ALL PE SIN LE
○ M.W.——	MONITORING	G WELL
4		
← G.W. —		
x	x	
		SANITARY/COMBINED SEWER
		OTOTAL OF MELL
		WATERMAIN OVERHEAD UTILITY LINES
— оп		OVERHEAD UTILITE LINES

SITE BENCHMARKS:

REFERENCE BENCHMARK DISC ON SE FACE OF 2ND COLUMN W OF NE'LY MOST COLUMNS N OD C OUTER DR & E OF C I-75 ELEV:589.24 (NAVD 88)

R/R SPIKE IN S FACE OF UTILITY POLE W OF OUTER DR R.O.W. & 50' E'LY OF HIGH TENSION POWER LINES

SITE BENCHMARK # 2 PK NAIL N SIDE CONC. LIGHT POLE BASE 50' S & 25' E OF SW PROPERTY CORNER

ELEV:583.17 (NAVD 88)

PK NAIL N. SIDE CONC. LIGHT POLE BASE 86' W & 6' S OF SE PROPERTY CORNER ELEV:584.78 (NAVD 88)

RIVERS EDGE APARTMENTS


PAVING AND GRADING PLAN


GEORGE JEROME & CO. SURVEY BY P.J. D.J.C. CONSULTING MUNICIPAL & CIVIL ENGINEERS • SURVEYORS ROSEVILLE, MI 48066 (586) 774-3000 CHECKED BY G.J.JR. scale 1"= 20' | FOR COMMUNITY CARE | DATE 4-5-16 APPROVED BY G.J.JR.


FIELD BOOK 1410 Pgs.1-3 DRAWING FILE NO. _





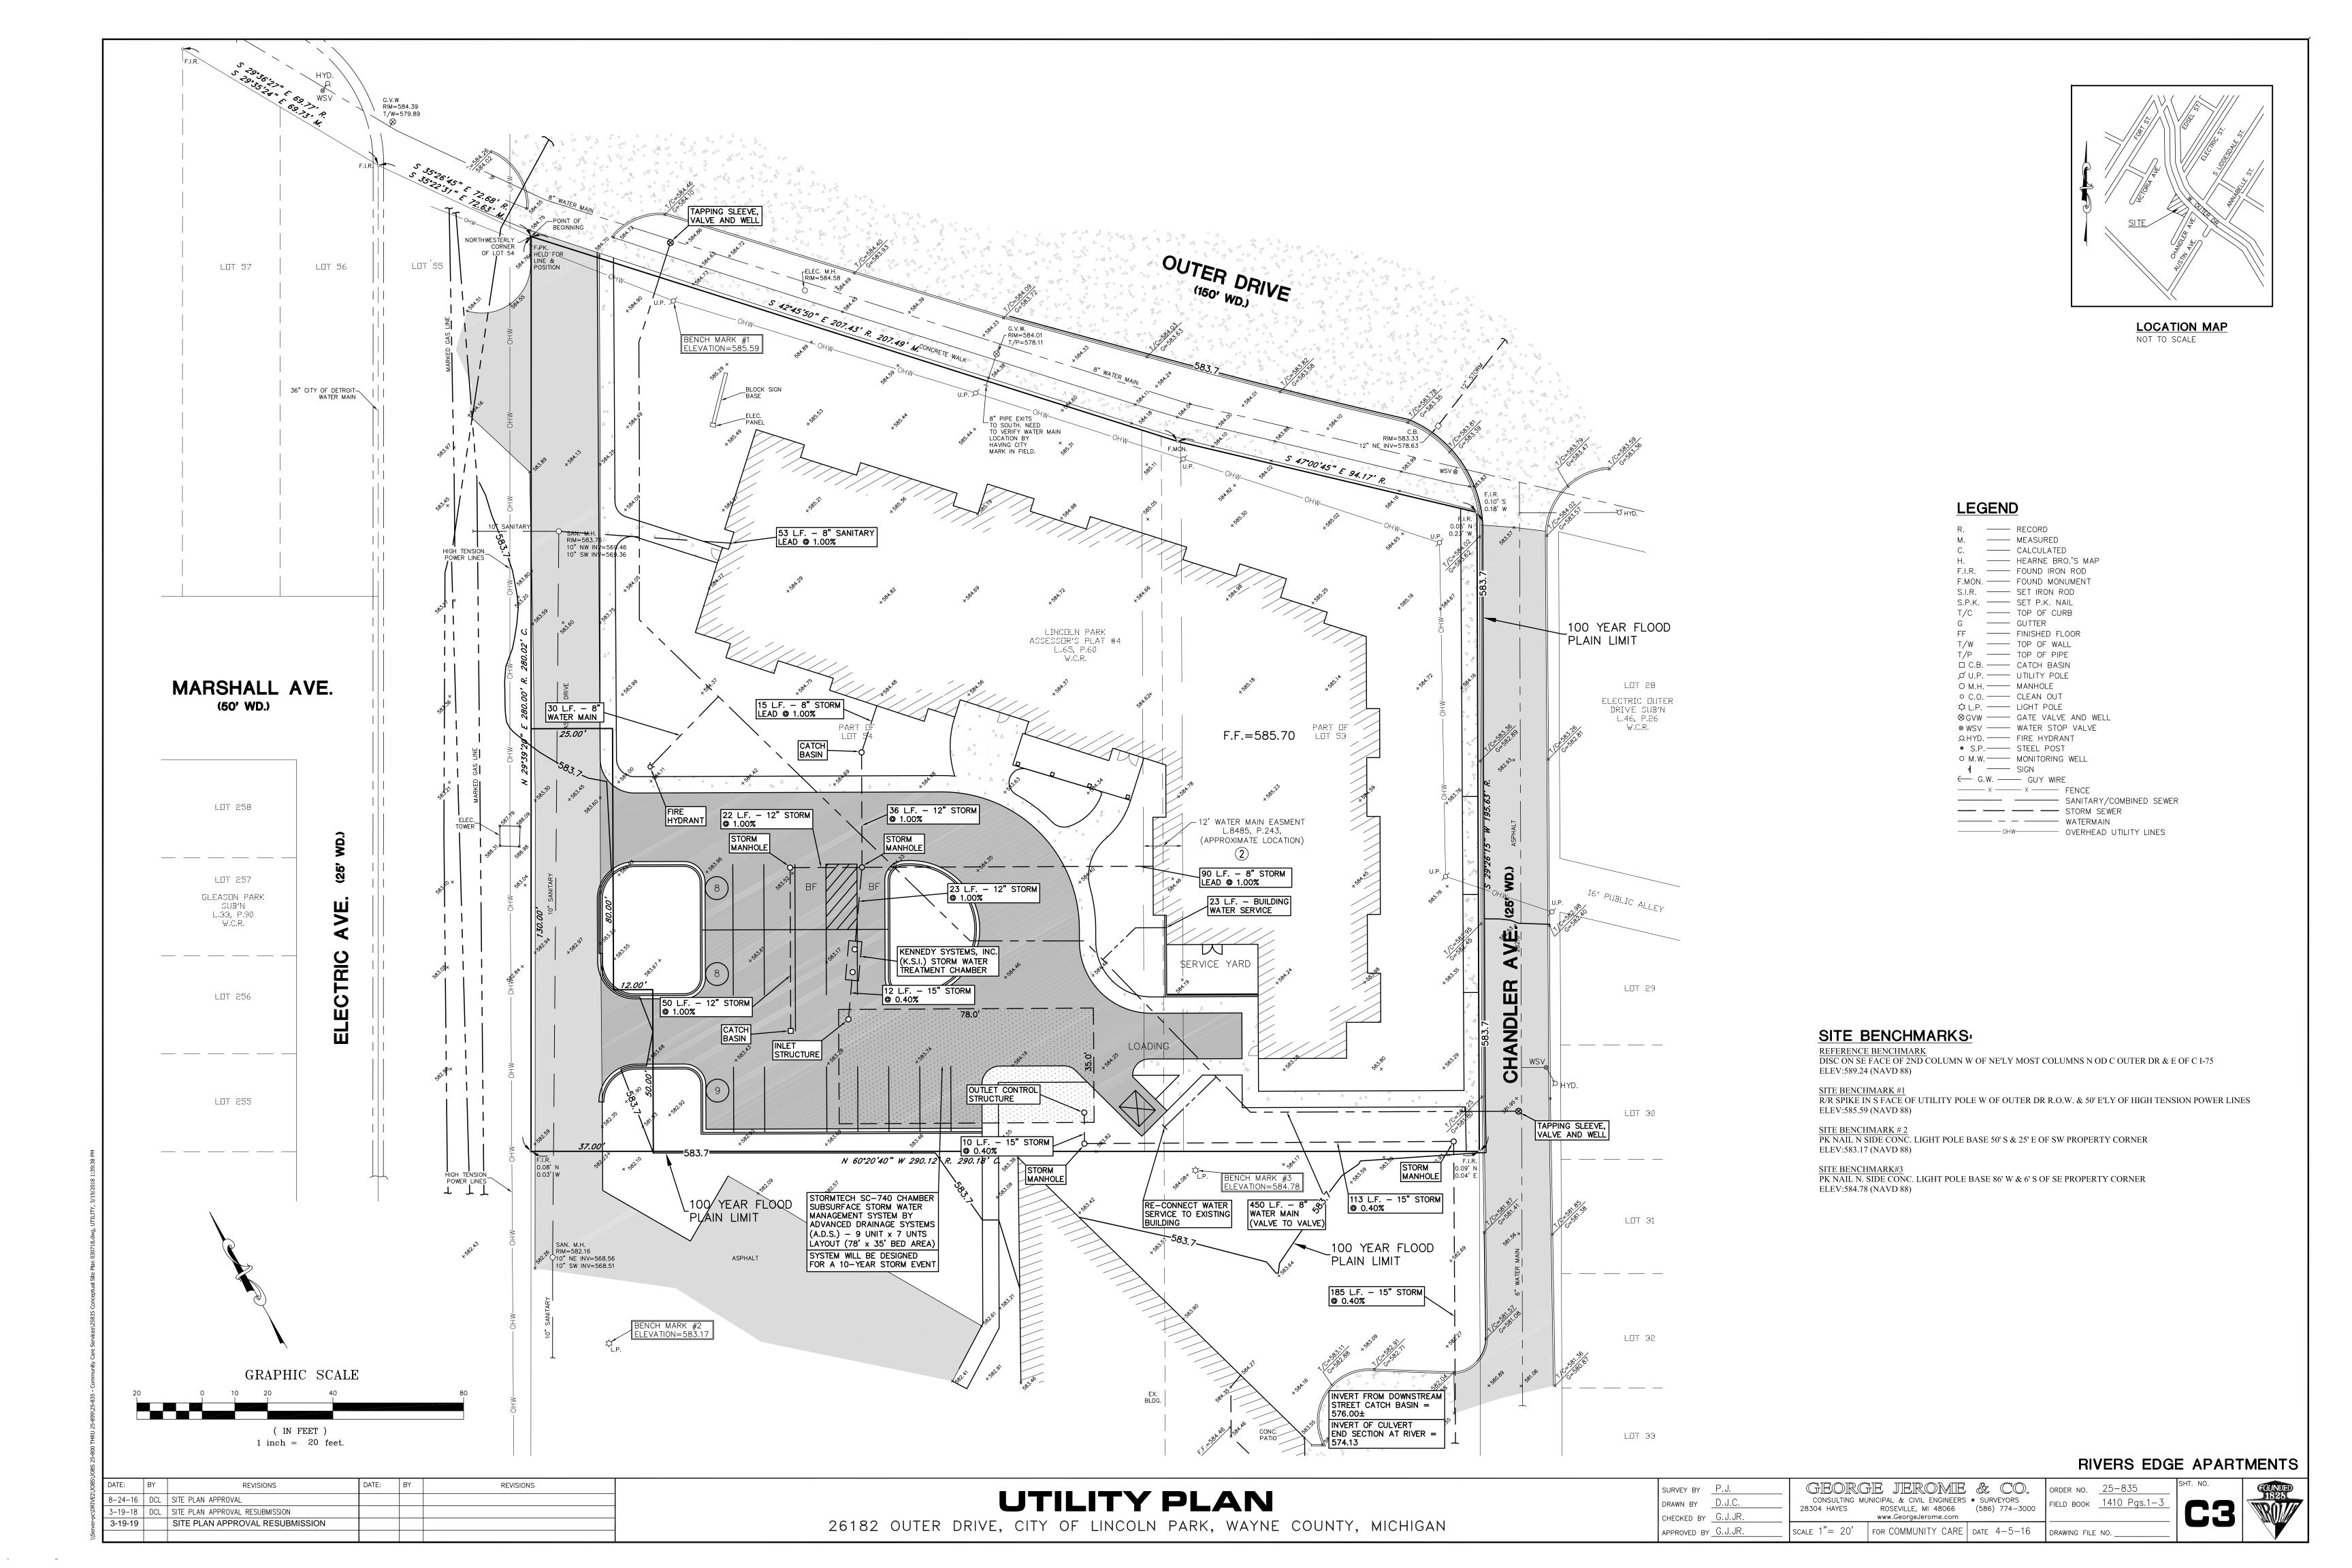

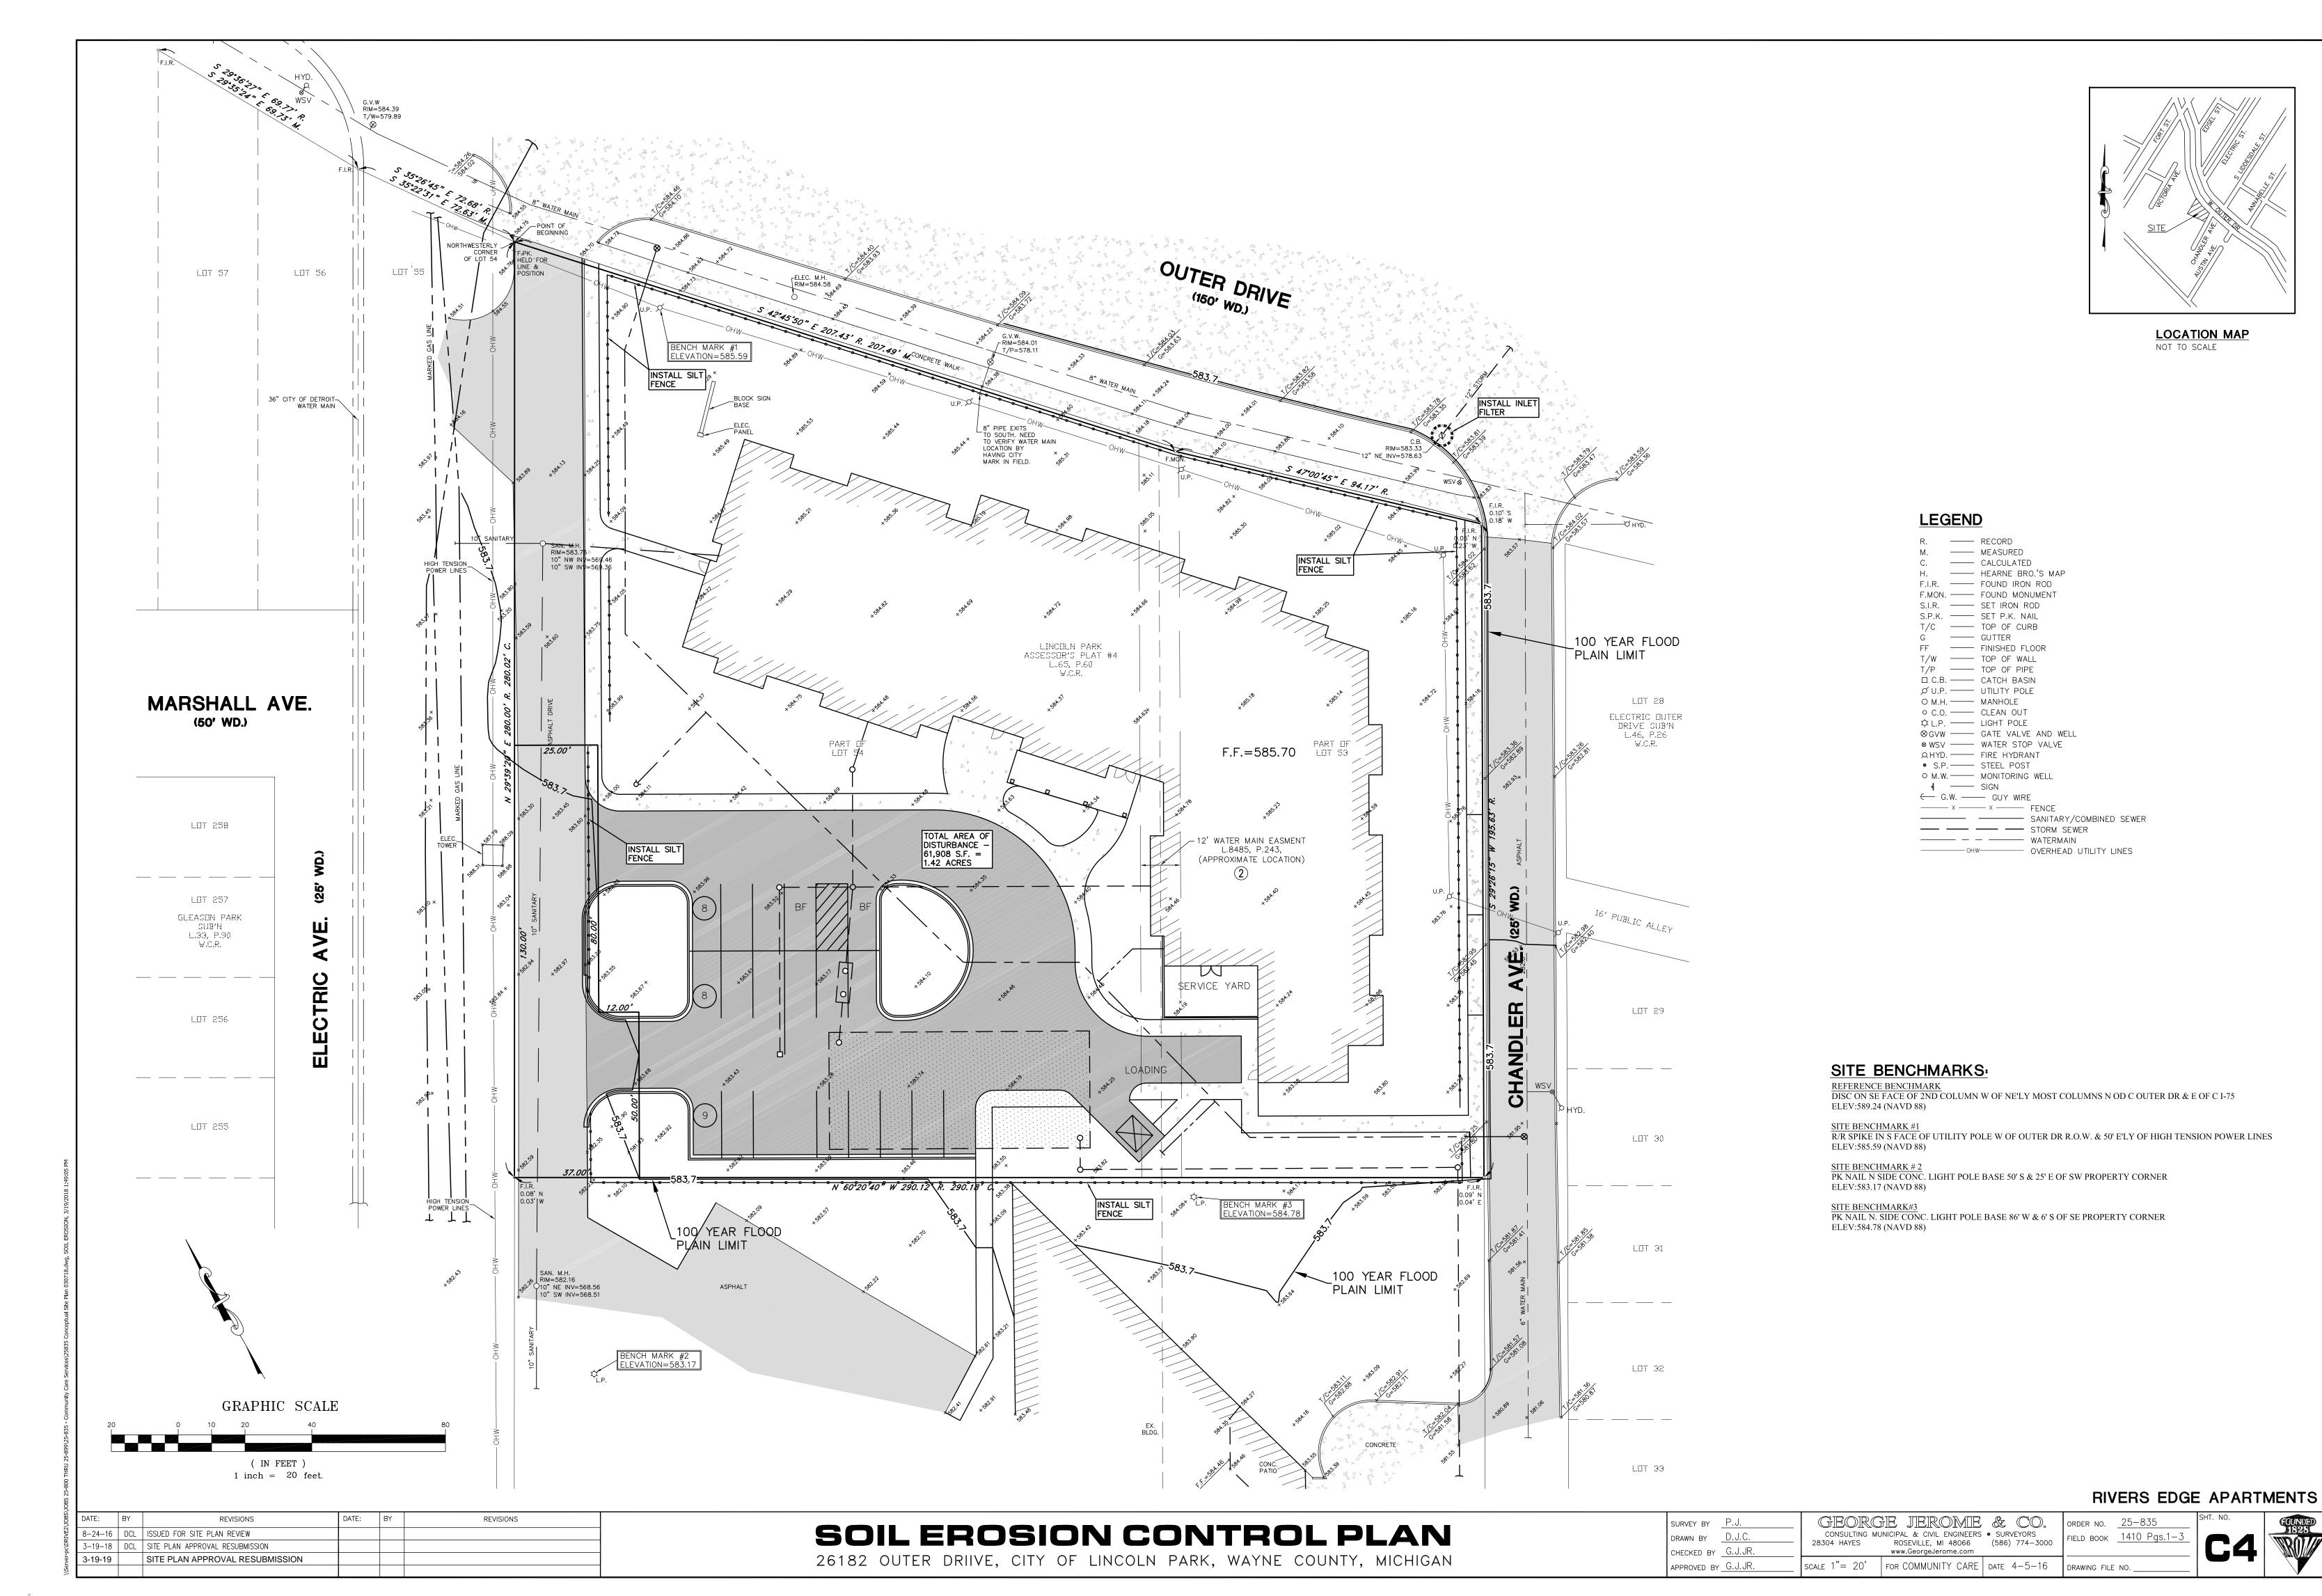

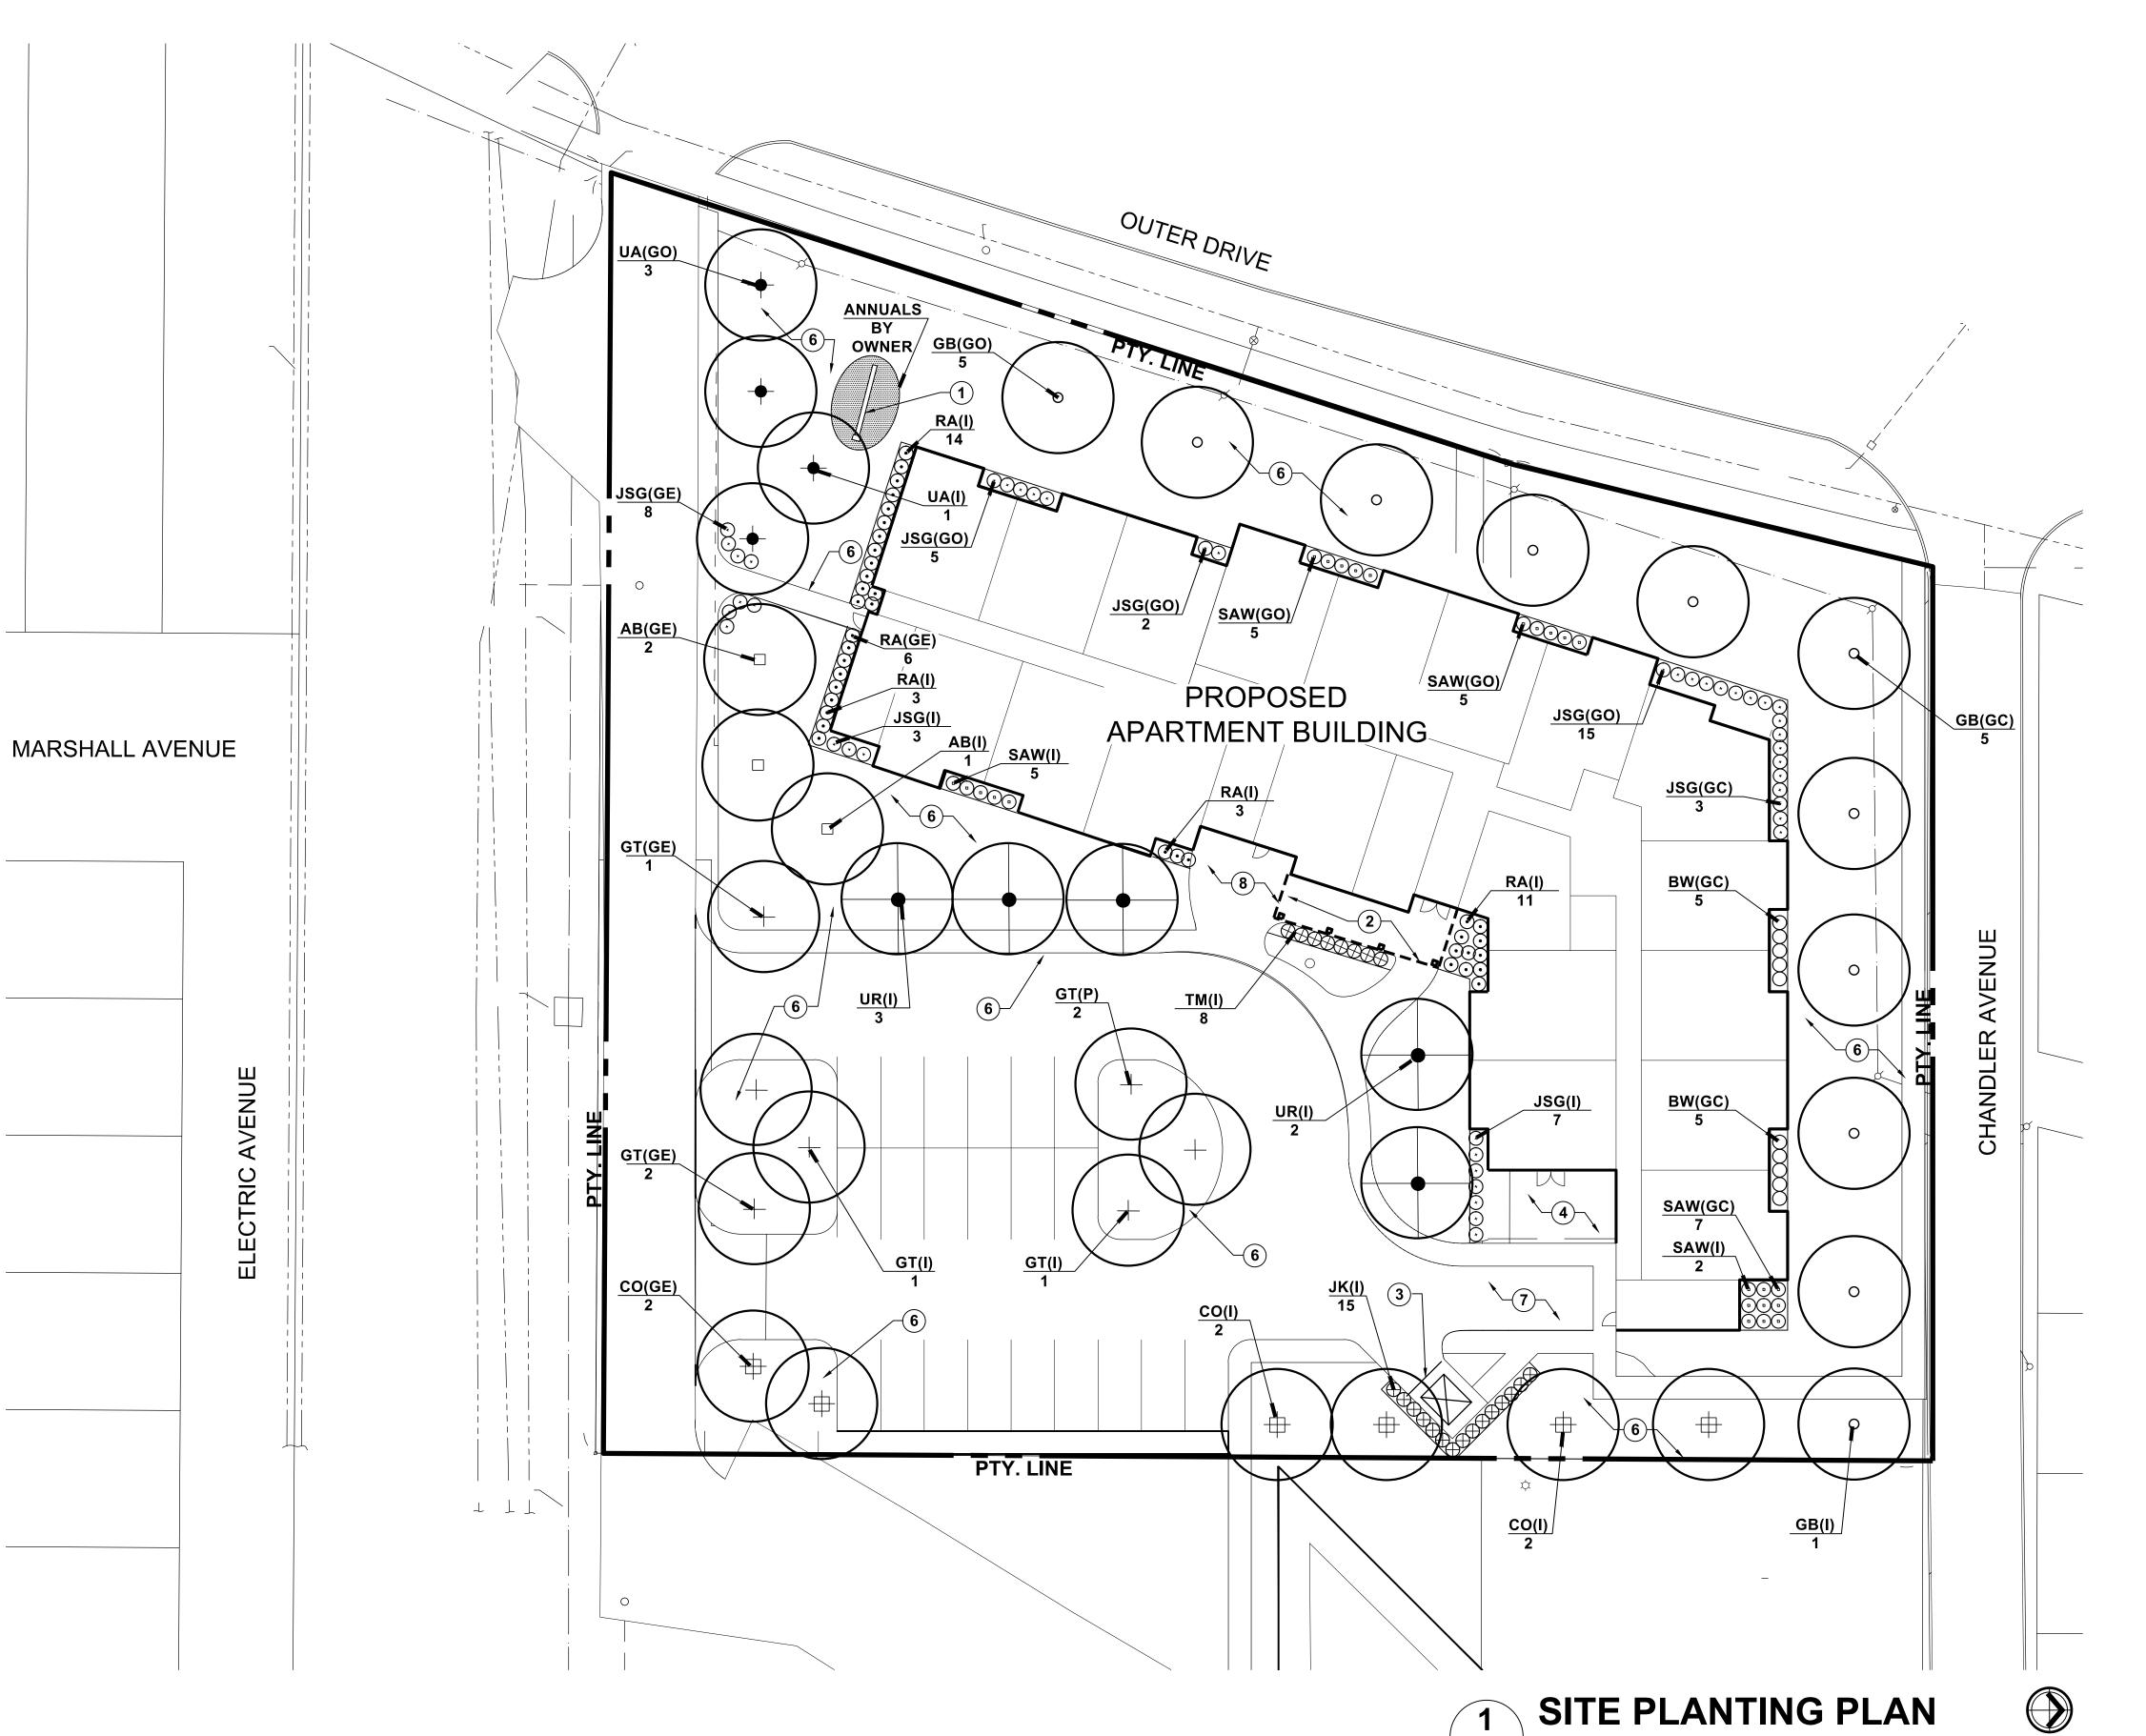

L.101 / SCALE 1" = 20'

NOTE KEY: 2

- 1) PROJECT SIGN SEE ARCH, PLANS
- 2 OVERHEAD CANOPY SEE ARCH. PLANS
- (3) DUMPSTER ENCLOSURE AREA SEE ARCH. PLANS
- (4) SERVICE YARD SEE ARCH. PLANS
- 5 SEEDED LAWN SEE NOTES BELOW

SYMMETRICAL CROWNS.

- (6) SIDEWALK SEE CIVIL PLANS
- 7 LOADING AREA
- (8) PATIO AREA

GENERAL PLANTING NOTES:

- ALL TREES TO HAVE CLAY OR LOAM BALLS, TREES WITH SAND BALLS <u>WILL BE REJECTED</u>.
- (B) ALL SINGLE STEM SHADE TREES TO HAVE STRAIGHT TRUNKS AND
- C ALL SINGLE TRUNK SHADE TREES TO HAVE A CENTRAL LEADER, TREES WITH FORKED OR IRREGULAR TRUNKS WILL NOT BE
- D ALL MULTI-STEM TREES SHALL BE HEAVILY BRANCHED AND HAVE SYMMETRICAL CROWNS. ONE SIDED TREES OR THOSE WITH THIN OR OPEN CROWNS SHALL NOT BE ACCEPTED.
- (E) ALL EVERGREEN TREES SHALL BE HEAVILY BRANCHED AND FULL TO THE GROUND, SYMMETRICAL IN SHAPE AND NOT SHEARED FOR THE LAST FIVE GROWING SEASONS.
- F) NO MACHINERY IS TO BE USED WITHIN THE DRIPLINE OF EXISTING TREES. HAND GRADE ALL LAWN AREAS WITHIN DRIPLINE OF
- (G) ALL TREE LOCATIONS SHALL BE STAKED BY LANDSCAPE CONTRACTOR AND ARE SUBJECT TO THE APPROVAL OF THE LANDSCAPE ARCHITECT PRIOR TO INSTALLATION OF THE PLANT
- (H) IT IS MANDATORY THAT POSITIVE DRAINAGE IS PROVIDED AWAY FROM ALL BUILDINGS, WALKS AND PAVED AREAS.
- ALL PLANTING BEDS SHALL RECEIVE 6" SHREDDED BARK MULCH. SEE SPECIFICATIONS.
- J SEE SPECIFICATIONS FOR ADDITIONAL COMMENTS, REQUIREMENTS, PLANTING PROCEDURES AND WARRANTY STANDARDS.

PLANT MIX

EXCAVATE PLANT BEDS TO DEPTH SHOWN ON DETAILS -DISPOSE OF SPOILS OFF SITE.

PLANTING BEDS AND PLANT PITS TO RECEIVE MIXTURE OF: 70% LOAM TOPSOIL, 10% COMPOST, 20% SAND;

ADDITIONALLY - HAND TILL INTO EVERY 150 SQ. FT. BED AREA AND/OR ADD TO EVERY ONE CUBIC YARD OF PLANT PIT MIX:

- (1) 6 CU. FT. BALE ORGANIC COMPOST
- (1) 40 LB BAG COMPOSTED POULTRY MANURE "CHICK MAGIC" 5-3-2 WWW.CHICKMAGIC.NET (262)495-6220
- (1) 5 LB BAG SHEMINS 13-13-13 MULTI PURPOSE FERTILIZER
- HAND TILL INTO BED TO MINIMUM DEPTH OF 12"

MULCH

MULCH TO BE DOUBLE SHREDDED HARDWOOD BARK MULCH

NO GROUND WOOD PALETTE MULCH PERMITTED

LANDSCAPE EDGING

ALL LANDSCAPE EDGES ARE SHOVEL CUT

LAWNS:

IRRIGATION SYSTEM

ALL LAWNS TO BE FESCUE SEED UNLESS NOTED

PROVIDE UNDERGROUND AUTOMATIC IRRIGATION SYSTEM. PROVIDE SHOP DRAWING INCLUDING SEPARATE ZONES FOR LAWNS, SHRUBS, PERENNIALS AND ANNUAL FLOWERS. INCLUDE QUICK COUPLERS FOR HAND WATERING AREAS IF NECESSARY. SUBMIT SHOP DRAWING TO ARCHITECT FOR REVIEW AND APPROVAL.

WATERING


CONTRACTOR RESPONSIBLE FOR MONITORING THE WATERING OF ALL PLANTINGS FOR ONE YEAR FROM THE START OF THE WARRANTY PERIOD.

PLANTINGS THAT PERISH DUE TO LACK OF WATER, OR TOO MUCH WATER, DO NOT QUALIFY AS THE ONE REQUIRED REPLACEMENT PLANT AS STATED IN THE SPECIFICATION, AND SHALL BE REPLACED AT NO COST TO THE OWNER.

CONTRACTOR IS ALSO RESPONSIBLE FOR MONITORING THE WATERING OF ALL NEWLY PLANTED LAWN AREAS FOR ONE YEAR FROM THE START OF THE WARRANTY PERIOD. NEWLY PLANTED LAWN AREAS THAT PERISH DUE TO LACK OF WATER, OR TOO MUCH WATER, DO NOT QUALIFY AS THE REQUIRED REPLACEMENT TO ESTABLISH A HEALTHY FULL DENSE LAWN AS STATED IN THE SPECIFICATION, AND SHALL BE REPLACED AT NO COST TO THE OWNER.

PLANTING KEY:

NORTH

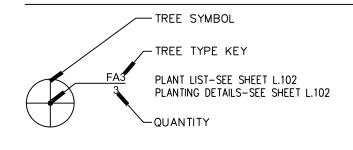



248 477 3600 TEL WWW.KW-LA.COM 33203 BIDDESTONE LANE, FARMINGTON HILLS, MI 48334



550 E. NINE MILE ROAD FERNDALE, MICHIGAN, 48220

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SEAL

PHONE 248.543.4100 FAX 248.543.4141

APARTMENT EDGE

O3.19.2019 SPA RESUBMISSION 03.19.2018 SPA RESUBMISSION

ISSUE HANDSCAPE ARCHITECT

08.24.2016 SPA

Site Plan Approval FSP PROJECT NO. COM16.023

DRAWING TITLE

SITE PLANTING PLAN

DRAWING NUMBER

The Elms specified are not American elm trees, which we all know have been decimated over the past 100 years in the American landscape, but special hybrids developed to replace the American Elm.

The Regal Elm - is a hybrid elm cultivar developed by the University of Wisconsin at Madison and released in 1983. 'Regal' was derived from seeds arising from the crossing of the Dutch hybrid clones of the Siberian elm and European smooth leaved elm (Ulmus pumila × 'Hoersholmiensis'), sent in 1960 by the De Dorschkamp Research Institute in the Netherlands.

The Regal elm casts a honeylocust-like light shade that makes possible the successful culture of turf grass in the vicinity of the tree

The 'Accolade' Elm - is a cross of the Japanese elm and Chinese elm, (Ulmus japonica x Ulmus wilsoniana)- and was developed by the Morton Arboretum in Chicago

It is an elm cultivar derived from an elm hybrid planted at the Morton Arboretum in 1924, which itself originated as seed collected from a tree at the Arnold Arboretum in Massachusetts.

Accolade Elm is a cross of Japanese and Chinese species selected for its vase shape, vigorous growth, excellent drought tolerance and good strong yellow fall color. It has excellent disease resistance to both Elm Yellows and to the dreaded Dutch Elm Disease. Mayor Daley of Chicago chose the Accolade Elm to bring elms back to Chicago's Grant Park in 2002.


The original tree at the Morton Arboretum is noted for its resemblance to the American Elm (*Ulmus americana*), its upright-arching branches creating the familiar vase-shape. Moreover, in its 80+ years it has survived three epidemics of Dutch Elm Disease there unscathed.


The Triumph Elm - is another elm developed at the Morton Arboretum

It is Asian hybrid - a cross between the 'Vangard Elm' and 'Accolade Elm' (parentage -Japanese, Chinese and Siberian elms)


All three of these elms have been selected for their fast growth and environmental tolerance.

All three of these elms have been specified by our office and are awaiting planting or have been specified and planted in Canton, Novi, Northville, West Bloomfield, Waterford, Shelby Township, Grand Blanc, the city of Detroit and projects in Illinois and Ohio.

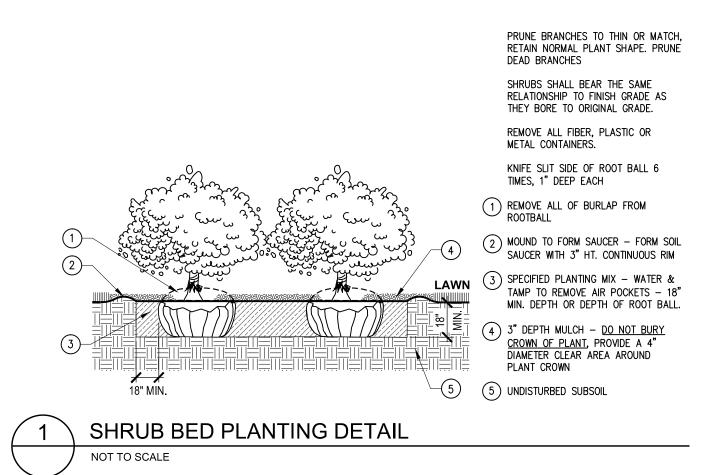

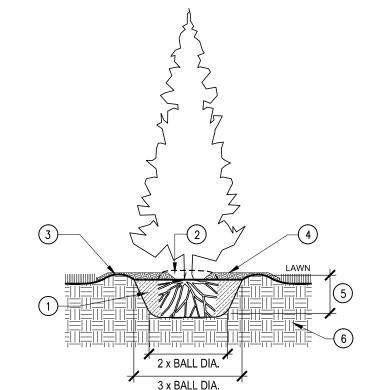


NOT TO SCALE

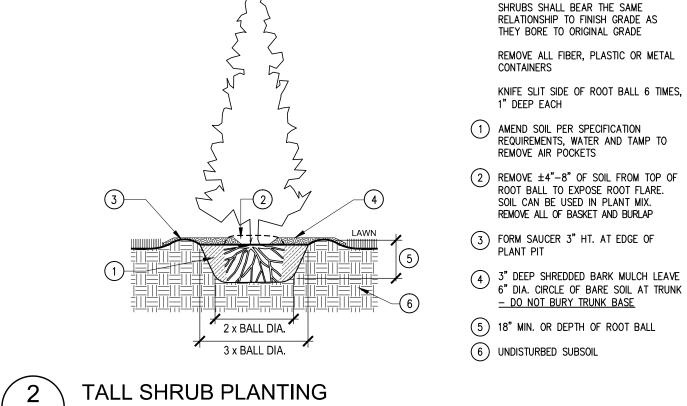


PRUNE BRANCHES TO THIN OR MATCH,

RETAIN NORMAL PLANT SHAPE.

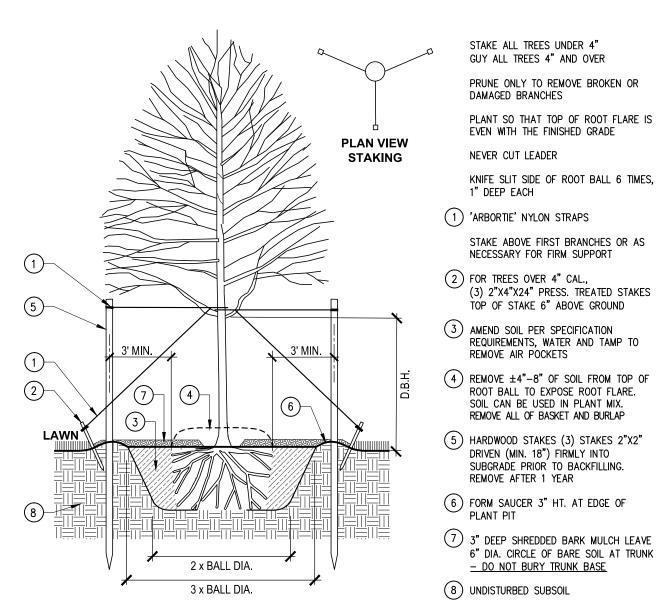

DECIDUOUS TREE PLANTING

NOT TO SCALE

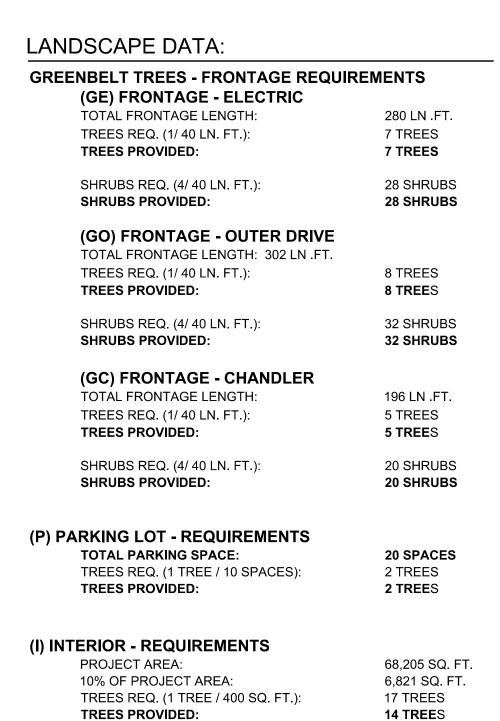

57 SHRUBS

SHRUBS PROVIDED:



550 E. NINE MILE ROAD FERNDALE, MICHIGAN, 48220 PHONE 248.543.4100 FAX 248.543.4141

SEAL

PLANT LIST - GREENBELT FRONTAGE - ELECTRIC (GE) COPYRIGHT 2015 - FUSCO, SHAFFER & PAPPAS, INC.

24" Spr.

B&B

QUAN. KEY COMMON/ BOTANICAL NAME SPEC. AB Autumn Blaze Maple 3" Cal. B&B Acer x. fremanii 'Autumn Blaze' CO 3" Cal. B&B Hackberry Celtis occidentalis B&B Thornless Honey Locust 3" Cal. Gledit. tria. iner. 'Skyline' B&B **Gro-Low Fragrant Sumac** 24" Spr. Rhus aromatica 'Gro-Low' **JSG** Sea Green Juniper 24" Spr. Cont.

PLANT LIST - GREENBELT FRONTAGE - OUTER DRIVE (GO) <u>KEY</u> COMMON/ BOTANICAL NAME SPEC.

GB Ginkgo 3" Cal. B&B Ginkgo biloba Accolade Elm 3" Cal Ulmus parviflora 'Morton' 24" Spr. Sea Green Juniper Juniperus 'Sea Green' SAW Anthony Waterer Spirea 24" Spr. B&B Spirea 'Anthony Watererii'

Juniperus 'Sea Green'

PLANT LIST - GREENBELT FRONTAGE - CHANDLER (GC) **KEY** COMMON/ BOTANICAL NAME SPEC. <u>SIZE</u> GB Ginkgo 3" Cal. B&B 5 Ginkgo biloba Green Velvet Boxwood 24" Ht. Cont. Buxus m. 'Green Velvet' **14 TREE**S JSG Sea Green Juniper 24" Spr. Cont. SHRUBS REQ. (1 SHRUB / 250 SQ. FT): 28 SHRUBS Juniperus 'Sea Green'

PLANT LIST - PARKING (P)

Spirea 'Anthony Watererii'

SAW Anthony Waterer Spirea

COMMON/ BOTANICAL NAME SPEC. GT Thornless Honey Locust 3" Cal. B&B Gledit. tria. iner. 'Skyline'

PLANT LIST - INTERIOR (I) COMMON/ BOTANICAL NAME <u>SIZE</u> SPEC. AB 3" Cal. B&B Autumn Blaze Maple Acer x. fremanii 'Autumn Blaze' Hackberry 3" Cal. Celtis occidentalis 3" Cal. B&B GB Ginkgo biloba Thornless Honey Locust 3" Cal. B&B Gledit. tria. iner. 'Skyline' Accolade Elm 3" Cal Ulmus parviflora 'Morton 3" Cal B&B UR Regal Elm Ulmus carpinifolia 'Regal' 24" Spr. JSG Sea Green Juniper Cont. Juniperus 'Sea Green' Ketler Juniper 6' Ht. B&B


Gro-Low Fragrant Sumac 24" Spr. Rhus aromatica 'Gro-Low SAW Anthony Waterer Spirea 24" Spr. Spirea 'Anthony Watererii' 24" Ht. Dense Yew Taxus x. m. 'Densiformis'

J. 'Ketlerii'

ARTMENT

EDGE

O3.19.2019 SPA RESUBMISSION 03.19.2018 SPA RESUBMISSION 08.24.2016 SPA

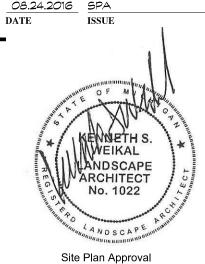

COM16.023

FSP PROJECT NO.

DRAWING TITLE


PLANT LIST & DETAILS

DRAWING NUMBER



33203 BIDDESTONE LANE, FARMINGTON HILLS, MI 48334


248 477 3600 TEL WWW.KW-LA.COM

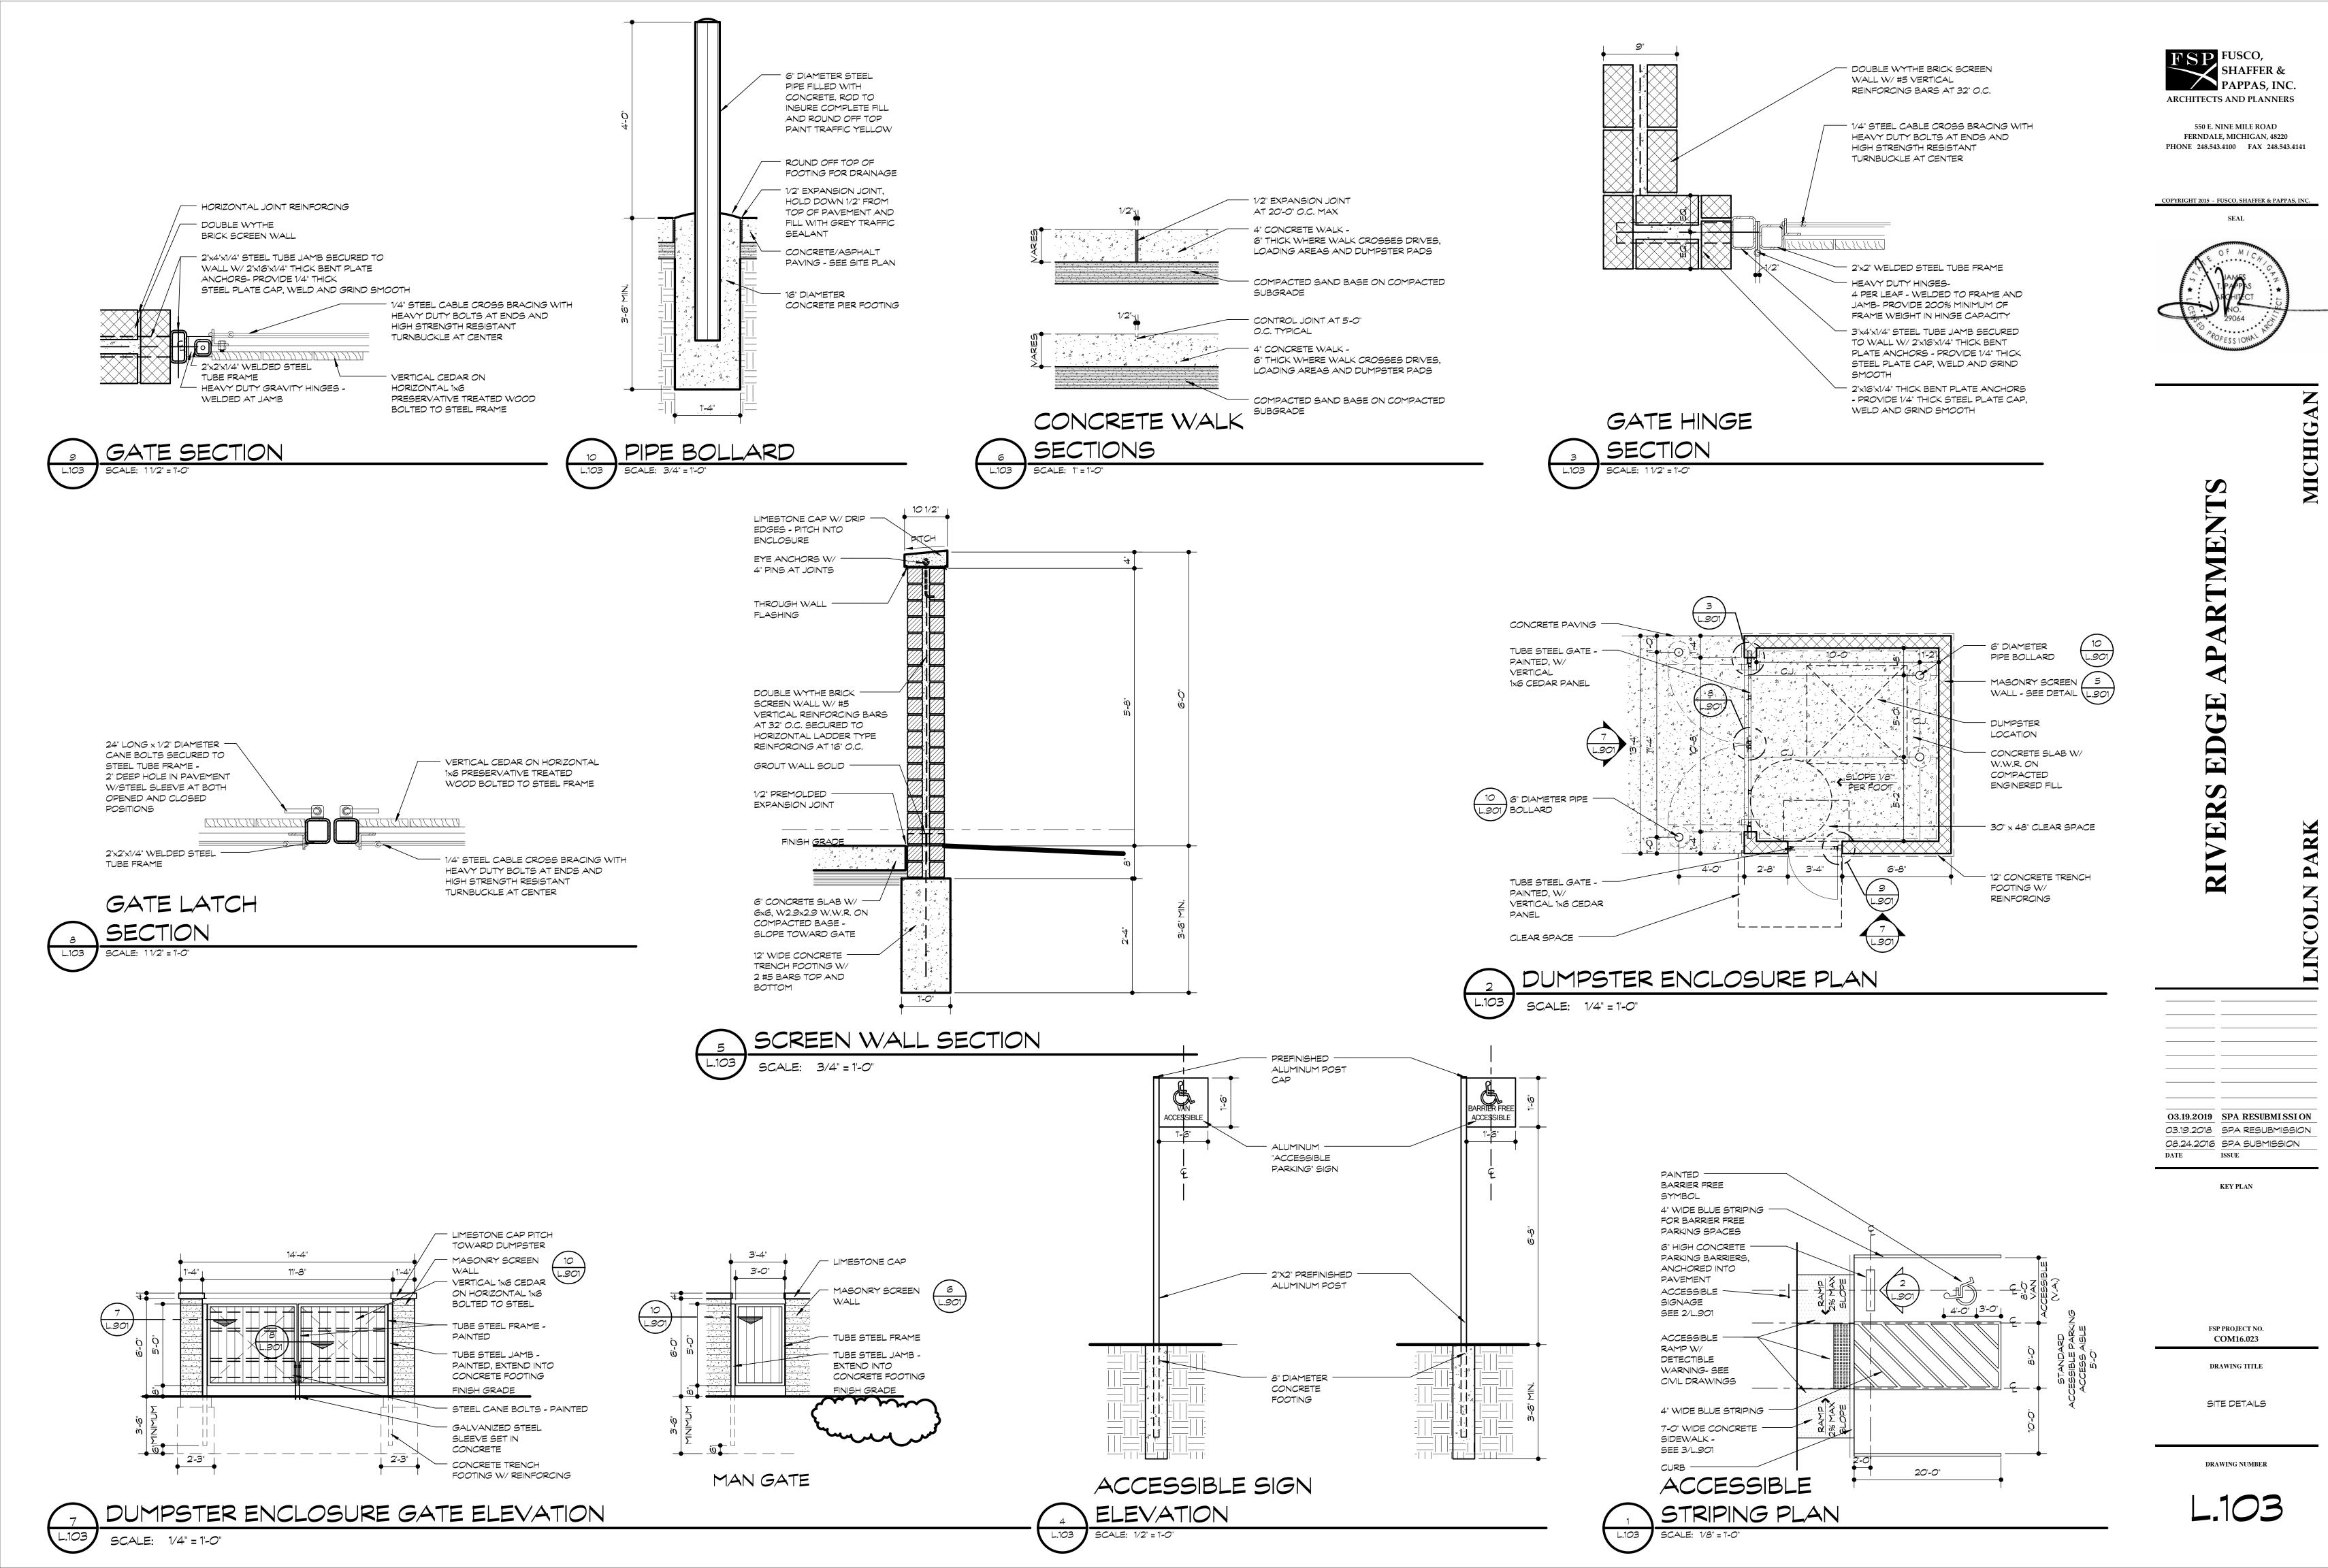

PLAN NORTH



550 E. NINE MILE ROAD PHONE 248.543.4100 FAX 248.543.4141

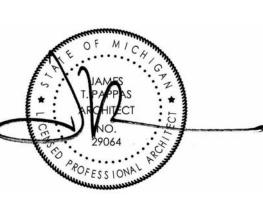

50%

27%

1.50

1,100 SF

LOT 33

ED

O3.19.2019 SPA RESUBMI SSI ON 03.19.18 SPA RESUBMISSION 03.27.2017 BOUNDARY

REVISION 09.16.2016 SPA REVISED SUBMISSION 08.24.2016 SPA SUBMISSION


KEY PLAN


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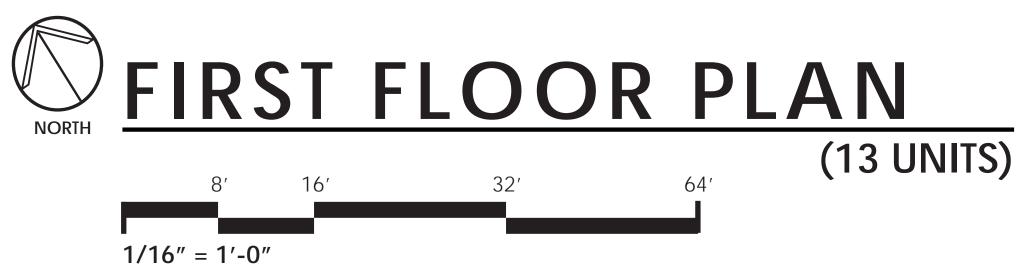
ARCHITECTURAL SITE PLAN

DRAWING NUMBER





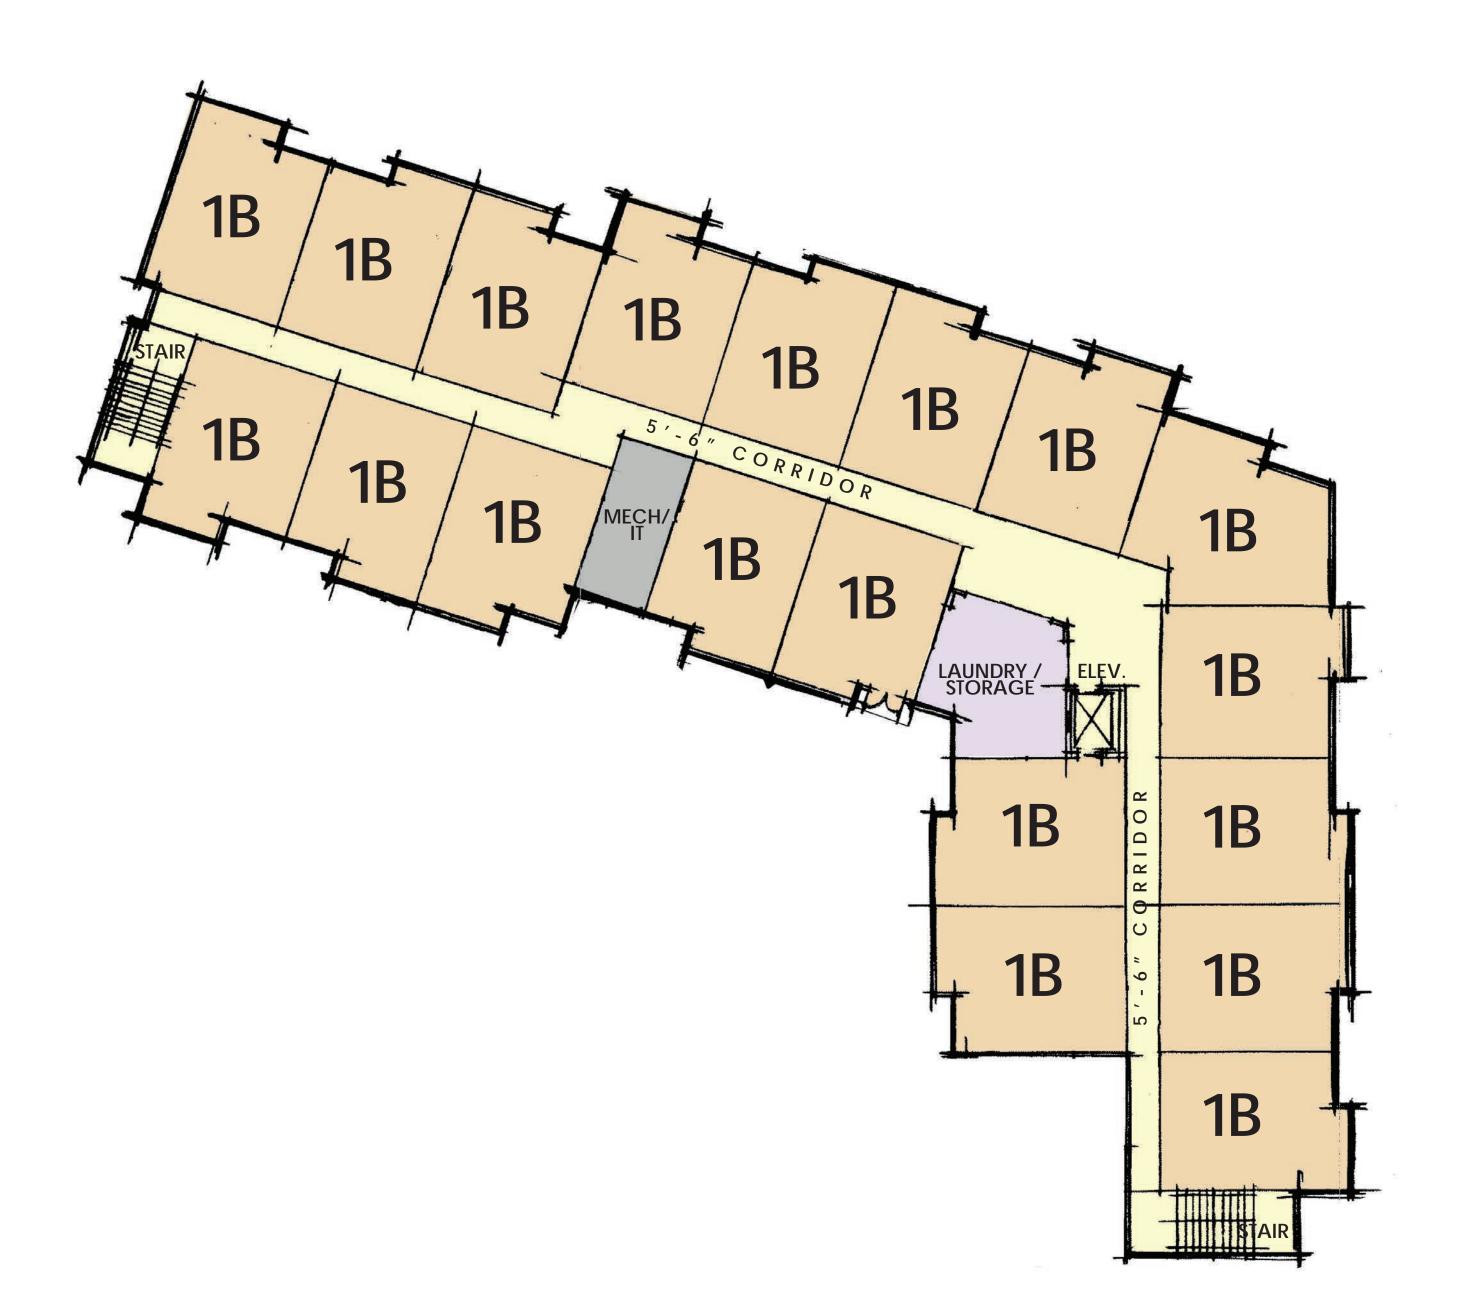

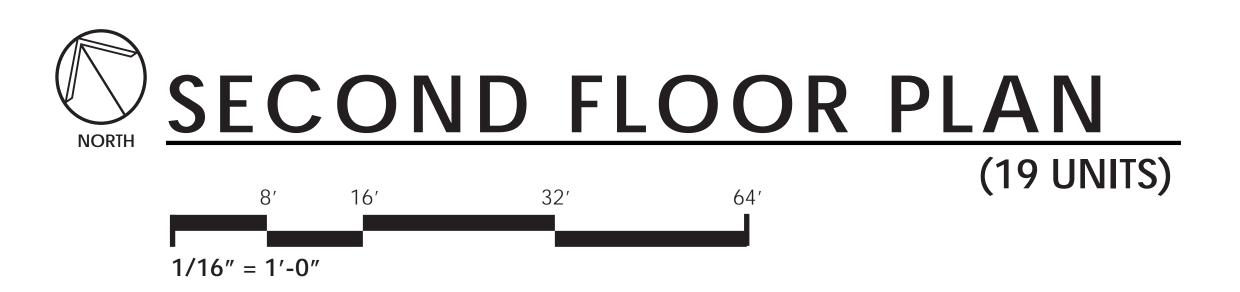

FSP FUSCO, SHAFFER & PAPPAS, INC.
ARCHITECTS AND PLANNERS

550 E. NINE MILE ROAD
FERNDALE, MICHIGAN, 48220

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RS EDGE APARTMENTS

MONIONI

O3.19.2019 SPA RESUBMISSION

3.19.2019 SPA RESUBMISS
3.19.2018 SPA RE-SUBMISS
8.24.2016 SPA SUBMISSIC
ISSUE

KEY PLAN

FSP PROJECT NO. COM16.023

DRAWING TITLE

FIRST/SECOND FLOOR PLAN

DRAWING NUMBER

A.101



550 E. NINE MILE ROAD

EDGE

PARAPET

L DECORATIVE LIGHT NORTHWEST ELEVATION

NORTHEAST ELEVATION (OUTER DRIVE)

3/32" = 1'-0"

ROOF TOP MECHANICAL EQUIPMENT TO BE SCREENED W/ HORIZONTAL SIDING SIDING 1 **BRICK**

ROOF DECK

3/32" = 1'-0"

3 SOUTHEAST ELEVATION (CHANDLER AVENUE) 3/32" = 1'-0"

ROOF TOP MECHANICAL EQUIPMENT TO BE SCREENED

W/ HORIZONTAL SIDING

ROOF TOP MECHANICAL EQUIPMENT TO BE SCREENED -- PAINTED METAL SUN-SHADE - SIDING 'B'

ALUMINUM COPING -

PAINTED METAL **SUN-SHADE**

SOUTHWEST ELEVATION

3/32" = 1'-0"

ROOF TOP MECHANICAL ROOF DECK

SOUTHEAST ELEVATION (FACING PARKING LOT) 3/32" = 1'-0"



6 SOUTHWEST ELEVATION (FACING PARKING LOT)

3/32" = 1'-0"

FSP PROJECT NO. COM16.023

DRAWING TITLE


O3.19.2019 SPA RESUBMISSION

KEY PLAN

EXTERIOR **ELEVATIONS**

DRAWING NUMBER A.201

NOTE: BUILDING HEIGHT (TO ROOF SURFACE) NOT TO EXCEED 25'-0". ELEVATIONS 3/32" = 1'-0"

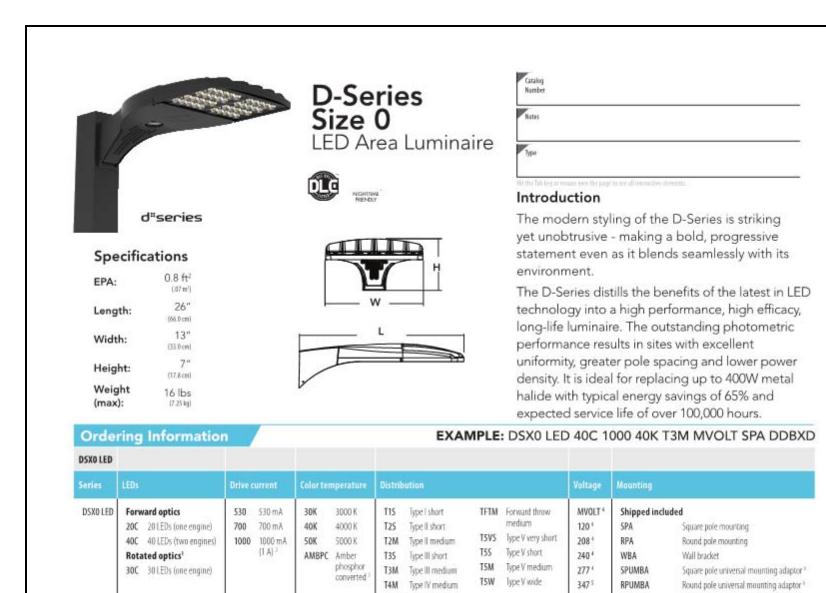

PIR1FC3V Motion/ambient sensor, 8-15' mounting height, ambient

PIRH1FC3V Motion/ambient sensor, 15-30'mounting height, ambient

BL30 Bi-level switched dimming, 30% 14.1

BL50 Bi-level switched dimming, 50% TL



PNMTDD3 Part night, dim till dawn 15 L90 Left rotated optics DNATXD Textured natural PNMT5D3 Part night, dim 5 hrs 15 R90 Right notated optics PNMT6D3 Part night, dim 6 hrs 15 DDL Diffused drop lens 18 DWHGXD Textured white PNMT7D3 Part night, dim 7 hrs 1 11 Specifies a ROAM® enabled luminaire with 0-10V dimming capability; PER option required. Additional hardware and services required for ROAM® deployment; must be purchased separately. Call 1-800-442-6745 or email: salestingamzervices.net; N/A with PERS, PER7, BL30, BL50 or PNMT. 30 LEDs (30C option) and rotated options (L90 or R90) only available 1000mA not available with AMBPC. AMBPC only available with 530mA or 700mA. options.

PIR and PIR1FC3V specify the SensorSwitch SBGR-1U ODP control, PIRH and PIRHFC3V specify the SensorSwitch SBGR-6-ODP control, see Motion Sensor Guide for details. Dimming driver standard. Not available with PERS or PER?. Ambient sensor disabled when ordered with DCR. Separate on/off required.

Requires an additional switched circuit.

Dimming driver standard. MVOLT only. Not evailable with 347V, 480V, DCR, PERS, PER? or PINMT options.

Dimming driver standard. MVOLT only. Not evailable with 347V, 480V. MVOLT driver operates on any line voltage from 120-277V (50/60 Hz). Specify 120V, 208V, 240V or 277V options only when ordering with fusing (SF, DF options). Volt available with single board, 530mA product (20C 530 or 30C 530). Not wailable with BL30, BL50 or PNMT options. Wailable as a separate combination accessory: PUMBA (finish) U; 1.5 G bration load rating per ANCI C136.31. Must be ordered as a separate accessory, see Accessories information. For use with 2-3/8" mast arm (not included). Dimming driver standard: MVOLT only. Not available with 347V, 480V, DCR, PERS, PER7, BL30 or BL50. Photocell ordered and shipped as a separate line item from Acuity Brands Controls. See accessories. Single fuse (SF) requires 120V, 277V or 347V. Double fuse (DF) requires 208V, 240V or 480V. 18 Requires luminaire to be specified with PER option. Ordered and shipped as a separate line item from Acuity Brands Controls. DMG option for 347V or 480V requires 1000mA. DSX0-LED Rev. 10/27/15 Page 1 of 4 One Lithonia Way . Conyers, Georgia 30012 . Phone: 800.279.8041 . Fax: 770.918.1209 . www.lithonia.com © 2011-2015 Acuity Brands Lighting, Inc. All rights reserved.

Shipped installed

Shipped separately 7

KMA8 DDBXD U Mast arm mounting bracket adaptor

DDBXD Dark bronze

DWHXD White

DOBTXD Textured dark bronze

DBLBXD Textured black

(specify finish)

HS House-side shield.19 DBLXD Black

SF Single fuse (120, 277, DNAXD Natural aluminum

LITHONIA LIGHTING.

WSTM LED 1A 40K 120 DDBTXD

WSTM LED 2A 40K 120 DDBTXD

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Shipped installed

PER NEMA twist-lock receptacle only (no controls).1

DCR Dimmable and controllable via ROAM® (no controls)

Controls & Shields

DLL347F1.5 CULJU Photocell - SSL twist-lock (347V) *

B DLL480F 1.5 CULJU Photocell - SSL twist-lock (480V) *

B DSX0H5 20C U House-side shield for 20 LED unit

SOURCE DESCRIPTION OF THE PROPERTY OF THE PROP

DSX0H5 40C U House-side shield for 40 LED unit DSXXDDL U Diffused drop lens (polycarbonate)

KWAR DDRXD U Mast arm mounting bracket adaptor (specify finish)?

FUMBA DORKD U* Square and round pole universal ring bracket adaptor (specify finish

For more control options, with OTL and MOAM online.

LITHONIA LIGHTING

PIR Motion/ambient sensor, 8-15' mounting height, ambient sensor enabled at 5fc 1

PIRH Motion/ambient sensor, 15-30' mounting height, ambient sensor enabled at 5fc. 10

PERS Five-write receptacle only (no controls) 10

PER7 Seven-wire receptacle only (no controls) a


DMG 0-10V dimming driver (no controls) 11


D-Series Size 1 Catalog Number LED Wall Luminaire





Specifications Back Box (BBW, ELCW) (34.9 cm) Weight: 4" ELCW (10.2 cm) Weight:

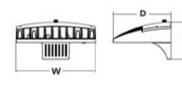

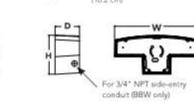

The D-Series Wall luminaire is a stylish, fully

integrated LED solution for building-mount applications. It features a sleek, modern design and is carefully engineered to provide long-lasting, energy-efficient lighting with a variety of optical and control options for customized performance.

With an expected service life of over 20 years of nighttime use and up to 74% in energy savings over comparable 250W metal halide luminaires, the D-Series Wall is a reliable, low-maintenance lighting solution that produces sites that are exceptionally illuminated.

Accessories

DSXWHS U House-side shield (one per light engine)

DSXWBSW U Bird-deterrent spikes

DSXWTWG U Wire guard accessory

DSXWTVG U Vandal quard accessory

EXAMPLE: DSXW1 LED 20C 1000 40K T3M MVOLT DDBTXD

ieries	LEDs		Drive C	urrent	Color ten	perature	Distribu	tion	Voltage	Mountin	ng	Contro	Options	Other	Options	Finish (requ	ired)
DSXW1 LED	10C 20C	10 LEDs (one engine) 20 LEDs (two engines)	350 530 700 1000	350 mA 530 mA 700 mA 1000 mA (T A)	30K 40K 50K AMBPC	3000 K 4000 K 5000 K Amber phosphor converted	T2S T2M T3S T3M T4M TFTM ASYDF	Type II Short Type II Medium Type III Short Type III Medium Type IV Medium Forward Throw Medium Asymmetric diffuse	MVOLT 1 120 1 208 1 240 1 277 1 347 2 480 3	Shippe (blank) BBW	d included Surface mounting bracket Surface mounted back box (for conduit entry) ³	Shipp PE DMG PIR PIRH	ed installed Photoelectric cell, button type 4 0-10V dim- ming driver (no controls) 180° motion/ ambient light sensor, <15' mtg ht 3 180° motion/ ambient light sensor, 15-30' mtg ht 4 Emergency battery backup (includes exter- nal component enclosure) 4	Shippinstal SF DF HS SPD Shippsepar BSW WG VG DDL	Single fuse (120, 277 or 347V)? Double fuse (208, 240 or 480V)? House-side shield? Separate surge protection?	DDBXD DBLXD DNAXD DWHXD DSSXD DDBTXD DBLBXD DNATXD DWHGXD DSSTXD	Dark bronze Black Natural aluminu White Sandstor Textured dark bronze Textured black Textured aluminu Textured white Textured sandstor

1 MVOLT driver operates on any line voltage from 120-277V (50/60 Hz). Specify 120, 208, 240 or 277 options only when ordering with fusing (SF, DF options), or

2 Only available with 20C, 700mA or 1000mA. Not available with PIR or PIRH. Back box ships installed on fixture. Cannot be field installed. Cannot be ordered as an accessory.
 Photocontrol (PE) requires 120, 208, 240, 277 or 347 voltage option. Not available with motion/ambient light sensors (PIR or PIRH).


5 PIR specifies the Sensor Switch SBGR-10-OOP control; PIRH specifies the Sensor Switch SBGR-6-OOP control; see Motion Sensor Guide for details. Includes ambient light sensor. Not available with "PE" option (button type photocall). Dimming driver standard. Not available with 20 LED/1000 mA configuration (DSXW1 LED 20C 1000).

6 Cold weather (-ZDC) rated. Not compatible with conduit entry applications. Not available with BBW mounting option. Not available with fusing. Not available

7 Single fuse (SF) requires 120, 277 or 347 voltage option. Double fuse (DF) requires 208, 240 or 480 voltage option. Not available with ELCW. 8 Also available as a separate accessory; see Accessories information 9 See the electrical section on page 3 for more details.

LITHONIA LIGHTING

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CONSTRUCTION — Durables quare metal reflectors retained by torsion springs. Galvanized steel mounting/plaster frame; galvanized steel junction box with bot tom-hinged access covers and spring latches.

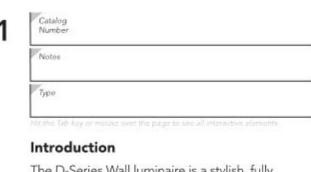Vertically adjustable mounting brackets with commercial bar hangers provide 3-3/4" total adjustment. Two combination 1/2"-3/4" and four 1/2" knockouts for straight-through conduit runs. Capacity: 8(4in, 4 out). No. 12 AWG conductors, rated for 90 °C. Accommodates 12"-24" joist spacing.

LITHONIA LIGHTING* Catalog Number

INTENDEDUSE — Typical applications include corridors, lobbies, conference rooms and private offices.

Passive cooling thermal management for 25°C standard; high ambient (40°C) option available. Light engine and drivers are accessible from above or below ceiling. Max ceiling thickness 1-1/2".

OPTICS — LEDs are binned to a 3-step SDCM; 80CR1 minimum. LED light source concealed with diffusing optical lens. General illumination lighting with 1.0 S/MH and 55° cutoff to source and source image.

FEATURES & SPECIFICATIONS

Self-flanged an odized reflectors in specular, semi-specular, or matte diffuse finishes. Also available in white and black painted reflectors. Self-flanged ano dized reflectors in specular, semi-specular, or matte diffuse finishes. ELECTRICAL — Multi-volt (120-277V, 50/60 Hz) eldo LED 0-10V dimming drivers mounted to junction box, 10% or 1% minimum dimming level available.

0-10V dimming fecture requires two (2) additional low-voltage wire sto be pulled. 70% lumen maintenance at 50,000 hours. LISTINGS — Certified to US and Canadian safety standards. Damp location standard (wet location covered ceilling optional).

WARRANTY — 5-year limited warranty. Complete warranty terms located at www.acuitybrands.com/CustomerResources/Terms_and_conditions.aspx Note: Actual performance may differ as a result of end-user environment and application. All values are design or typical values, measured under laboratory conditions at 25 °C.

Specifications subject to change without notice.

DO WN LIGHTING



.DN4SQ																
ieries	Color temp			Finis	Finish Voltage		e	Driver		Options						
LDN4SQ 4" square	30/ 35/	2700 K 300 0 K 3500 K 400 0 K	05 10 15 20 25 30	500 lumens 1000 lumens 1500 lumens 2000 lumens 2,500 lumens 3000 lumens	L54 L5W4	Downlight Wallwash	AR WR ² BR ²	Clear White Black	LSS LD LS	Semi- specular Matte diffuse Specular	MVOLT 120 277 347 ¹	Multi-volt 120V 277V 347V	EZ10	eldoLED 1% 0-10V eldoLED 10% 0-10V	SP* TRW1 TRBL1 EL* ELR* NPS80EZ* NPS80EZER1 HAO CP WL RRL_	Single fuse White painted flange Black painted flange Batterypack (integral tests witch Batterypack (integral pack controls 0-10V eldoLED drivers. Light" dimming pack controls 0-10V eldoLED drivers. ER controls fortures on emergency circuit. High ambient option (40°C) Chicago Plenum Wet location Wet location RELOC"- ready luminaire con- nectors enable a simple and consistent factory installed option across all ABL luminaire brands. Refer to R.L. for complet romenclature. Available only in RRLA, RRLB, RRLAE, and RRLC12'

Overall height varies based on lumen package; refer to dimensional chart on page 3. Not available with finishes. Not available with emergency options. Must specify voltage 120V or 277V. 5 Available with clear (AR) reflector only.

LD N4SO

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> <u>Plan View</u> Scale - 1" = 30ft

GENERAL NOTE

1. SEE SCHEDULE FOR LUMINAIRE MOUNTING HEIGHT.

0.0 0.0 0.0

2. SEE LUMINAIRE SCHEDULE FOR LIGHT LOSS FACTOR. 3. CALCULATIONS ARE SHOWN IN FOOTCANDLES AT GRADE.

THE ENGINEER AND/OR ARCHITECT MUST DETERMINE APPLICABILITY OF THE LAYOUT TO EXISTING / FUTURE FIELD CONDITIONS. THIS LIGHTING LAYOUT REPRESENTS ILLUMINATION LEVELS CALCULATED FROM LABORATORY DATA TAKEN UNDER CONTROLLED CONDITIONS IN ACCORDANCE WITH ILLUMINATING ENGINEERING SOCIETY APPROVED METHODS. ACTUAL PERFORMANCE OF ANY MANUFACTURER'S LUMINAIRE MAY VARY DUE TO VARIATION IN ELECTRICAL VOLTAGE, TOLERANCE IN LAMPS, AND OTHER VARIABLE FIELD CONDITIONS. MOUNTING HEIGHTS INDICATED ARE FROM GRADE AND/OR FLOOR UP.

THESE LIGHTING CALCULATIONS ARE NOT A SUBSTITUTE FOR INDEPENDENT ENGINEERING ANALYSIS OF LIGHTING SYSTEM SUITABILITY AND SAFETY. THE ENGINEER AND/OR ARCHITECT IS RESPONSIBLE TO REVIEW FOR MICHIGAN ENERGY CODE AND LIGHTING QUALITY COMPLIANCE.

Statistics							
Description	Symbol	Avg	Max	Min	Max/Min	Avg/Min	Avg/Max
DRIVEWAY	Ж	1.8 fc	3.8 fc	0.6 fc	6.3:1	3.0:1	0.5:1
PARKING AREA	Ж	2.1 fc	3.1 fc	1.0 fc	3.1:1	2.1:1	0.7:1

Symbol	Label	QTY	Manufacturer	Catalog Number	Description I	Lamp	Number Lamps	Filename	Lumens per Lamp	LLF	Wattage	Mounting Height
	Α	2	Lithonia Lighting	DSX0 LED 40C 1000 40K T5W MVOLT	DSX0 LED with 40 LEDs @1000 mA , 4000K, Type 5 Wide Optics	LED	1	DSX0_LED_40C_1000_40K _T5W_MVOLT.ies	15741	0.9	276	20'-0"
	В	1	Lithonia Lighting	DSX0 LED 40C 1000 50K T2M MVOLT	DSX0 LED with 40 LEDs @1000 mA , 5000K, Type 2 Medium Optics	LED	1	DSX0_LED_40C_1000_50K _T2M_MVOLT.ies	14986	0.9	138	20'-0"
	С	2	Lithonia Lighting	WSTM LED 2A 40K 120 DIFS	WSTM LED WITH 2 BOARDS, 4000K CCT, 120 VOLT, DIFFUSE GLASS LENS	SAMSUNG 2323	1	WSTM_LED_2A_40K_120_D IFS.ies	1277	0.9	16.2	8'-0"
	D	1	Lithonia Lighting	DSXW1 LED 20C 1000 40K TFTM MVOLT	DSXW1 LED WITH (2) 10 LED LIGHT ENGINES, TYPE TFTM OPTIC, 4000K, @ 1000mA.	LED	1	DSXW1_LED_20C_1000_40 K_TFTM_MVOLT.ies	7711	0.9	73.2	15'-0"
	Е	4	Lithonia Lighting	LDN4SQ 40/10 LS4AR LD	4IN SQUARE LDN, 4000K, 1000LM, 80CRI, CLEAR, MATTE DIFFUSE REFLECTOR	LED	1	LDN4SQ_40_10_LS4AR_LD. ies	978	0.9	12.58	10'-0"

03.19.2019 SPA RESUBMISSION Designer

LM/AAM Date 8/24/2016 Scale Not to Scale Drawing No. #16-59913-V1

E.101